

LAKE STREET ELEVATION (LOOKING NORTH)

PREPARED BY:

ARCHITECT PETER QUINN ARCHITECTS LLC

259 ELM ST. STE 301 SOMERVILLE, MA 02144

PH (617) 354 3989

CIVIL ENGINEERS & LAND SURVEYOR

DESIGN CONSULTANTS, INC. 120 MIDDLESEX AVE SOMERVILLE, MA 02145 PH (617) 776 3350

LANDSCAPE VERDANT LANDSCAPE ARCHITECTS 318 HARWARD ST, STE 25 **BROOKLINE. MA 02446**

PASSIVE HOUSE CONSULTANT ZERO ENERGY DESIGN 156 MILK ST. STE 3

BOSTON, MA 02109 PH (617) 720 5002

PH (617) 735 1180

PROGRAM SUMMARY - PASSIVE HOUSE PROJECT

- 13,951 LOT AREA
- 56,573-GSF TOTAL BUILDING (INCLUDES STRUCTURED PARKING)
- 51,271-GSF (GROSS RESIDENTIAL)
- 15 PARKING SPACES
 - 13 BELOW BUILDING ON GROUND LEVEL
 - 2 OUTSIDE BUILDING
- 71 BIKE SPACES (65 LONG-TERM, 6 SHORT-TERM)
- 4 COMMON AMENITIES
 - 1 ROOF DECK & GREEN ROOF
 - 3 COMMON ROOMS @ GROUND FLOOR
- 59 UNITS (USING 850 SF/UNIT RATIO)
 - 26 STUDIO
 - 24 ONE-BEDROOMS
 - 6 TWO-BEDROOMS
 - 3 THREE-BEDROOMS

INCLUDING ELEVEN (11) AFFORDABLE UNITS PLUS PAYMENT

THE LOT IS LEGACY KNOWN AS 3-7 HAWKINS ST, 3 LAKE ST. ASSESSOR'S MAP 75, BLOCK B, LOT 17

DEMOLITION APPROVAL WAS RECEIVED TO REMOVED ALL EXISTING STRUCTURES FROM SITE

NOTE - THIS APPLICATION IS A REVISION UNDER THE NEW CITY-WIDE ZONING BY LAW. PREVIOUS APPLICATION (11/25/2019) WAS UNDER PREVIOUS ZONING BY LAW.

FIRST FLOOR PLAN

4 - ONE BEDROOM UNITS

SECOND FLOOR PLAN

- 8 STUDIOS
- 5 ONE BEDROOM UNITS
- 1 TWO BEDROOM UNIT
- 1 THREE BEDROOM UNIT

THIRD FLOOR PLAN

- 8 STUDIOS
- 5 ONE BEDROOM UNITS
- 1 TWO BEDROOM UNIT
- 1 THREE BEDROOM UNIT

FOURTH FLOOR PLAN

- 8 STUDIOS
- 5 ONE BEDROOM UNITS
- 1 TWO BEDROOM UNIT
- 1 THREE BEDROOM UNIT

FIFTH FLOOR PLAN

- 2 STUDIOS
- 5 ONE BEDROOM UNITS
- 3 TWO BEDROOM UNITS

REDEVELOPMENT OF 3 HAWKINS ST A PASSIVE HOUSE PROJECT

SOMERVILLE, MA 02143

| | DRA APPL | | | |
|---|-------------|-------------|-------------|-------------|
| LIST OF DRAWINGS | | REV-1 | REV-2 | REV-3 |
| | 14 JUL 2020 | 23 OCT 2020 | 28 JAN 2021 | 08 APR 2021 |
| GENERAL / ZONING | | | | |
| T1 TITLE SHEET | Х | Х | Х | Х |
| EXISTING PLOT PLAN | Х | Х | Х | Х |
| Z1 ZONING COMPLIANCE (ZONING TABLE) | Х | Х | Х | Χ |
| Z2 ZONING COMPLIANCE (DIMENSIONAL SITE PLAN) | Х | X | X | Χ |
| Z3 ZONING COMPLIANCE (LOT COVERAGE) | Х | Х | Х | Χ |
| Z4 ZONING COMPLIANCE (BUILDING AREA) | Х | Х | Х | Х |
| Z5 ZONING COMPLIANCE (BLDG HEIGHT, GROUND STORY ELEV) | | X | X | Χ |
| Z6 ZONING COMPLIANCE (FACADE COMPOSITION) | Х | Х | Х | Х |
| Z7 ZONING COMPLIANCE (OUTDOOR AMENITY SPACE) | Х | Х | Х | Х |
| EC1 EXISTING CONDITIONS PHOTOS | Х | Х | Х | Χ |
| ARCHITECTURAL | | | | |
| A0.1-0.5 3D STREET VIEWS | X | X | X | X |
| AS-1 SITE PLAN | X | X | X | X |
| A1 BASEMENT PLAN | X | X | X | X |
| A2 FIRST FLOOR PLAN | X | X | X | X |
| A3 SECOND TO FOURTH FLOOR PLAN | X | X | X | X |
| A4 FIFTH FLOOR PLAN | X | X | X | X |
| A5 ROOF PLAN | Х | Х | Х | Х |
| A6 LAKE ST ELEVATION | Х | Х | Х | Х |
| A7 HAWKINS ST ELEVATION | Х | Х | Х | Х |
| A8 REAR ELEVATION | Х | Х | Х | Х |
| A9 PARK ELEVATION | Х | Х | Х | Х |
| A10 BUILDING SECTION | Х | Х | Х | Х |
| A11 MAJOR EXTERIOR MATERIALS | Х | Х | Х | Х |
| A12 LIGHTING PLAN | Х | Х | Х | Х |
| SHADOW STUDY (3 SHEETS) | Х | Х | Х | Х |
| | | | | |

NOTE - A LANDSCAPE DESIGN AND GREEN SCORE IS PROVIDED AS A SEPARATE DOCUMENT (PDF)



PLANNING

PETER QUINN ARCHITECTS II 259 FLM STREET, SUITE 301 SOMERVILLE, MA 02144 PH 617-354-3989

CONSULTANT

3 HAWKINS ST

3 HAWKINS ST SOMERVILLE, MA 02143

PREPARED FOR

HAWKINS STREET UNION SQ LLC


7 MORRISON RD WEST WAKEFIELD, MA 01880


TITLE SHEET

DRAWING TITLE

SCALE AS NOTED

| REVISION | DATE |
|-----------|-------------|
| | |
| DRA REV-3 | 08 APR 202 |
| DRA REV-2 | 28 JAN 202 |
| DRA REV-1 | 23 OCT 202 |
| DRA APPL | 14 JULY 202 |
| DRAWN BY | REVIEWED BY |
| MN / YC | PQ |

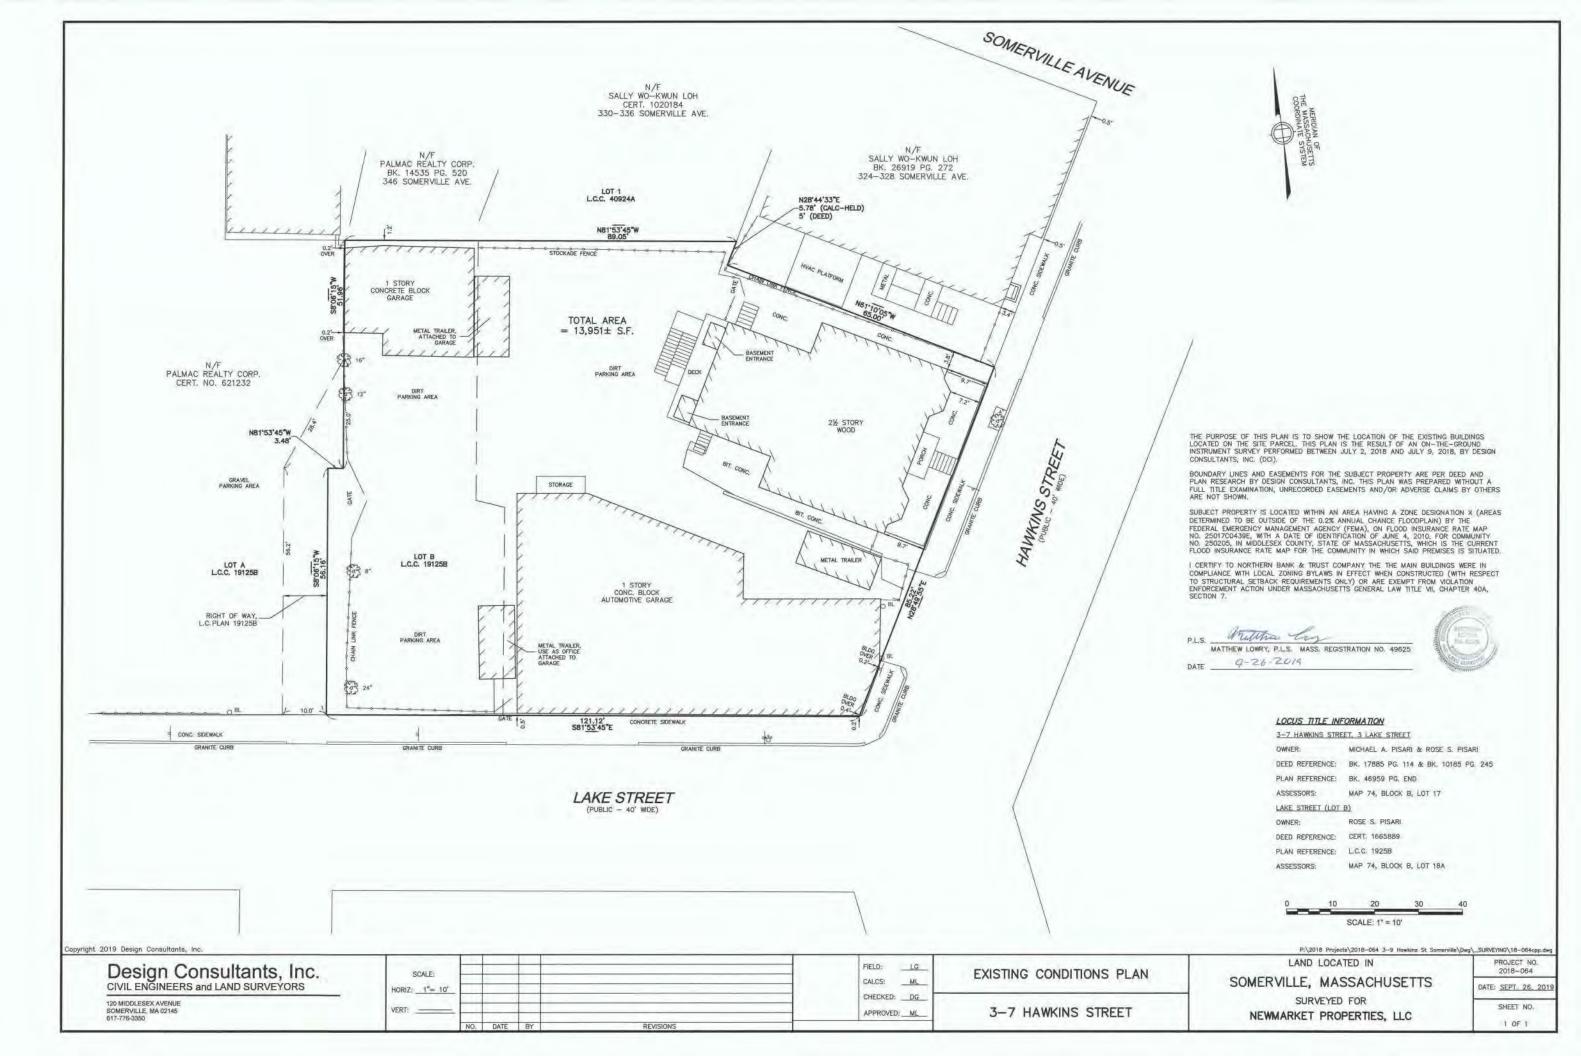

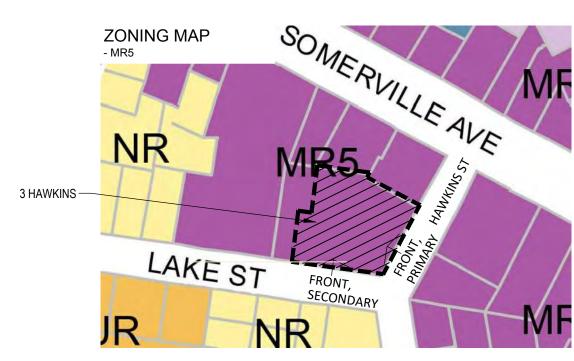





3 HAWKINS ST, DIMENSIONAL TABLE - MID RISE 5 (MR5) - APARTMENT BUILDING 1,9

| | ITEM | ALLOWED/ REQUIRED | PROPOSED | COMPLIANCE |
|-----------------|---|--|---------------------------------|----------------------|
| | BUILDING TYPE | PER 4.3.6 ¹ | APARTMENT BLDG | COMPLIES |
| | LOT AREA (SF) | NONE | 13,951 | N/A |
| ГОТ | LOT WIDTH (FT) | 30 min | 119.3' | COMPLIES |
| 27 | LOT COVERAGE (%) | 90 max ² | 79 78 | COMPLIES |
| | GREEN SCORE | 0.2 min ² | 0.25 0.23 | COMPLIES |
| | OPEN SPACE (%) | 15% min ² | 46% 47% | COMPLIES |
| | FRONT (PRIMARY - HAWKINS) SETBACK (FT) | 2 min, 12 max ³ | 8.5 to sheathing | COMPLIES |
| 4CKS | FRONT (SECONDARY - LAKE) SETBACK (FT) | 2 min, 12 max ³ | 7.5 to sheathing | COMPLIES |
| SETBACKS | SIDE YARD "A" SETBACK (ABUTTING NON-NR) (FT) | 0 3 | 5.1 to sheathing | COMPLIES |
| 0) | SIDE YARD "B" SETBACK (ABUTTING NON-NR) (FT) | 0 3 | 5.5 to sheathing | COMPLIES |
| | BUILDING WIDTH (FT) | 200 max ⁴ | 114.7 to exterior finish | COMPLIES |
| | FACADE BUILD OUT (PRIMARY) (%) | 80 min ⁴ | 86 | COMPLIES |
| | FACADE BUILD OUT (SECONDARY) (%) | 65 min ⁴ | 95 | COMPLIES |
| | FLOOR PLATE (SF) | 20,000 max ⁴ | 11,273 11,338 | COMPLIES |
| BUILDING | GROUND STORY ELEVATION (FT) | 2 min ⁴ | 2.3 | COMPLIES |
| BUILI | STORY HEIGHT (FT) | 10 min ⁴ | 11 | COMPLIES |
| | NUMBER OF STORIES | 3 min, 5 max ⁴ | 5 | COMPLIES |
| | STEP-BACK, 5TH STORY (FT) | 10 min ⁴ | 10 | COMPLIES |
| | BUILDING HEIGHT (FT) | | 58.63 | COMPLIES |
| | ROOF TYPE | FLAT ⁴ | FLAT | COMPLIES |
| ш | GROUND STORY FENESTRATION (%) - PRIMARY - SECONDARY | 15 min, 50 max ⁵ 15 min, 50 max ⁵ | 15 (Hawkins) 23 (Lake) | COMPLIES COMPLIES |
| FACADE | UPPER STORY FENESTRATION (%) - PRIMARY - SECONDARY | 15 min, 50 max ⁵ 15 min, 50 max ⁵ | 18-24 (Hawkins) 21-30 (Lake) | COMPLIES COMPLIES |
| | BLANK WALL (FT) | 20 max ⁵ | 18.5 | COMPLIES |
| λ | GROSS FLOOR AREA PER DU (NET ZERO READY BUILDING) | 850 min / DU ⁵ | 51,271 / 59 DU = 871 | COMPLIES |
| USE & OCCUPANCY | OUTDOOR AMENITY SPACE | 1/DU or common ⁵ | SEE SHEET Z-7 | COMPLIES |
| 100C | NO. OF PARKING | 59 max ¹⁰ | 15 | COMPLIES |
| E & C | NO. OF LONG-TERM BIKE PARKING | 59 min ¹⁰ | 65 | COMPLIES |
| SN | NO. OF SHORT-TERM BIKE PARKING | 6 min ¹⁰ | 6 | COMPLIES |
| ADUs | 4 OR MORE UNITS | 11.8 ⁶ | 11 plus 0.8 payment | COMPLIES |

ALL DIMENSIONS ARE APPROXIMATE AND BASED ON PLOT PLAN BY DESIGN CONSULTANTS, INC., 120 MIDDLESEX AVE, SOMERVILLE, MA 02145, DATED 26 SEP 2019. SEE DIMENSIONAL SITE PLAN ON SHEET Z-2 FOR CONFIRMATION OF DIMENSIONS HERE.

FOOTNOTES 1-11 - SEE SEPARATE LIST OF ZONING REFERENCES WITH RESPONSES.

PETER QUINN ARCHI TECTS

PLANNING COMMUNITY DESIGN

PETER QUINN ARCHITECTS LLC 259 ELM STREET, SUITE 301 SOMERVILLE, MA 02144 PH 617-354-3989



CONSULTANT

3 HAWKINS ST

3 HAWKINS ST. SOMERVILLE, MA 02143

PREPARED FOR

HAWKINS STREET UNION SQ LLC

7 MORRISON RD WEST WAKEFIELD, MA 01880

DRAWING TITLE

ZONING COMPLIANCE (DIMENSIONAL TABLE)


SCALE AS NOTED

| REVISION | DATE |
|-----------|-------------|
| | |
| DRA REV-3 | 8 APR 2021 |
| DRA REV-2 | 28 JAN 2021 |
| DRA REV-1 | 23 OCT 2020 |
| DRA APPL | 14 JUL 2020 |
| DRAWN BY | REVIEWED BY |

HFFT

Z-1

Jsers\admin\Documents\MYY\pqa\Hawkins-3\02 Schematic Design MY\Hawkins 3 - Zoning sidewalk.dwg, 08-Apr-21 7:04:25 PM, DWG To PDF.pc3

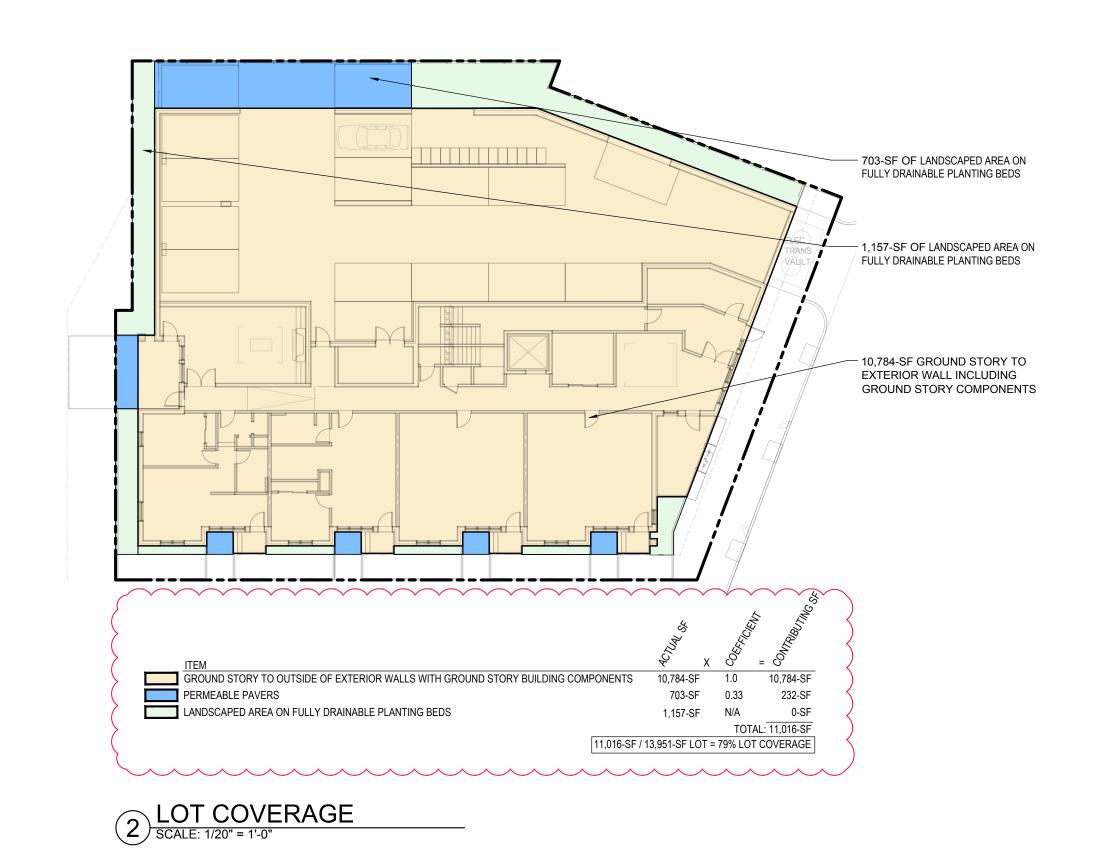

PETER QUINN ARCHI TECTS

ARCHITECTURE
PLANNING
COMMUNITY DESIGN

PETER QUINN ARCHITECTS LLC 259 ELM STREET, SUITE 301 SOMERVILLE, MA 02144 PH 617-354-3989



CONSULTAN

ROJECT

3 HAWKINS ST

3 HAWKINS ST. SOMERVILLE, MA 02143

PREPARED FOR

HAWKINS STREET UNION SQ LLC

7 MORRISON RD WEST WAKEFIELD, MA 01880

DRAWING TITLE

ZONING COMPLIANCE (LOT COVERAGE)

SCALE AS NO

| REVISION | DATE |
|-----------|------------|
| | |
| DRA REV-3 | 8 APR 2021 |
| DRA REV-2 | 28 JAN 202 |
| DRA REV-1 | 23 OCT 202 |
| | |


 DRA APPL
 14 JUL 2020

 DRAWN BY
 REVIEWED BY

 MY
 PQ


SHEET

Z-3

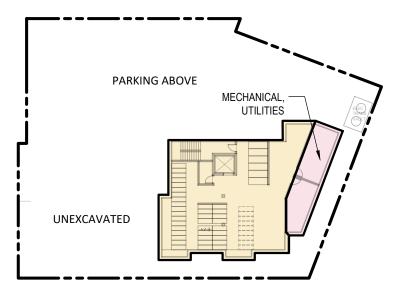


BASEMENT: 3,355-GSF (TOTAL AREA) 2,809-GSF (RESIDENTIAL) 546-GSF (NONRESIDENTIAL)


BASEMENT = 1,624-GSF (NONRESIDENTIAL AREA)

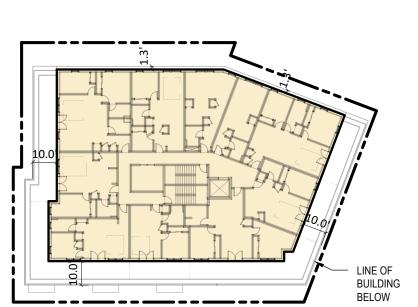


FIFTH FLOOR = 8,472-GSF FIFTH FLOOR = 8,450-GSF

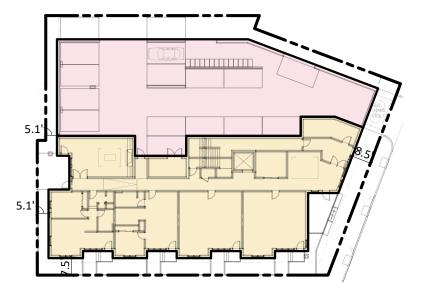

FIRST FLOOR: 10,374-GSF (TOTAL AREA) 4,756-GSF (NONRESIDENTIAL AREA) 5,618-GSF (RESIDENTIAL AREA)

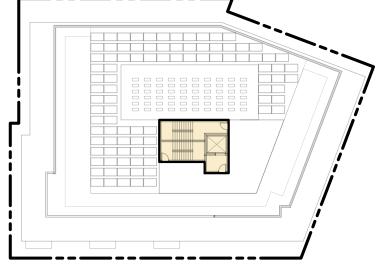

ROOF LEVEL = 553-GSF

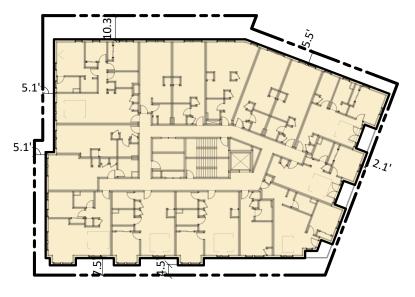

SECOND FLOOR = 11,273-GSF THIRD FLOOR = 11,273-GSF FOURTH FLOOR = 11,273-GSF

SECOND FLOOR = 11,338-GSF THIRD FLOOR = $\frac{1}{1338}$ -GSF FOURTH FLOOR = 11,338-GSF

GROSS FLOOR AREA *

| FLOOR | RES GSF | NONRES GSF |
|--------------------|---------|-------------------|
| BASEMENT | 2,809 | 546 |
| 1ST FL | 5,618 | 4,756 |
| 2ND FL | 11,273 | |
| 3RD FL | 11,273 | |
| 4TH FL | 11,273 | |
| 5TH FL | 8,472 | |
| ROOF | 553 | |
| TOTAL | 51,271 | 5,302 |
| GRAND TOTAL GFA | 56,573 | 56,746 |

^{*} PER ZONING BY-LAW DEFINITION

DIMENSIONALLY COMPLIANT FIVE-STORY

PROPOSED GROSS FLOOR AREA



PLANNING COMMUNITY DESIGN PETER QUINN ARCHITECTS LLC 259 ELM STREET, SUITE 301 SOMERVILLE, MA 02144



PH 617-354-3989

3 HAWKINS ST

3 HAWKINS ST. SOMERVILLE, MA 02143

PREPARED FOR

HAWKINS STREET UNION SQ LLC

7 MORRISON RD WEST WAKEFIELD, MA 01880

DRAWING TITLE

ZONING COMPLIANCE (BUILDING AREA)

SCALE AS NOTED

| REVISION | DATE |
|-----------|-------------|
| | |
| DRA REV-3 | 8 APR 2021 |
| DRA REV-2 | 28 JAN 2021 |
| DRA REV-1 | 23 OCT 2020 |
| DRA APPL | 14 JUL 2020 |

REVIEWED BY

PLANNING

259 FLM STREET, SUITE 301 SOMERVILLE, MA 02144 PH 617-354-3989



3 HAWKINS ST

3 HAWKINS ST. SOMERVILLE, MA 02143

PREPARED FOR

HAWKINS STREET UNION SQ LLC

7 MORRISON RD WEST WAKEFIELD, MA 01880

DRAWING TITLE


ZONING COMPLIANCE


- BLDG HEIGHT - GROUND STORY **ELEVATION**
- STORY HEIGHTS

| SCALE AS NOTED | | |
|----------------|------|--|
| REVISION | DATE | |

| DRA REV-3 | 8 APR 2021 |
|-----------|-------------|
| DRA REV-2 | 28 JAN 2021 |
| DRA REV-1 | 23 OCT 2020 |
| DRA APPL | 14 JUL 2020 |
| DRAWN BY | REVIEWED BY |
| MV | I DO |

SCALE: 1/20" = 1'-0"

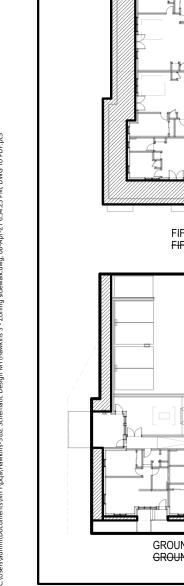

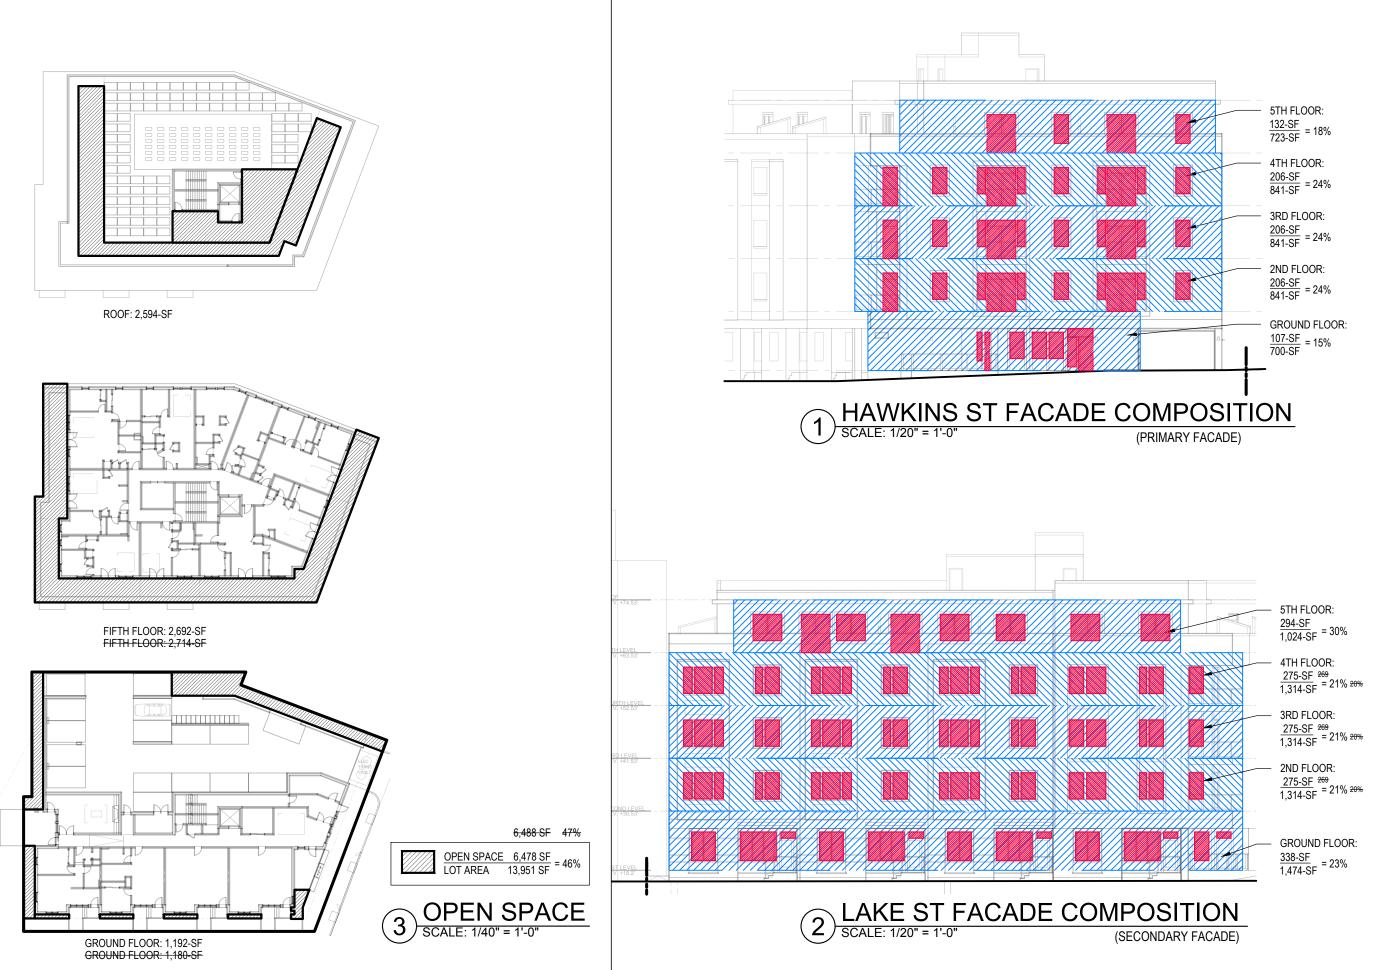

PLANNING **COMMUNITY DESIGN**

PETER QUINN ARCHITECTS LLC 259 ELM STREET, SUITE 301 SOMERVILLE, MA 02144 PH 617-354-3989



3 HAWKINS ST

3 HAWKINS ST. SOMERVILLE, MA 02143

PREPARED FOR

HAWKINS STREET UNION SQ LLC

7 MORRISON RD WEST WAKEFIELD, MA 01880

DRAWING TITLE


ZONING COMPLIANCE

-- FACADE COMPOSITION

SCALE AS NOTED

REVISION DATE


DRA REV-3 8 APR 2021 DRA REV-2 28 JAN 2021 DRA REV-1 23 OCT 2020 DRA APPL 14 JUL 2020 REVIEWED BY PQ

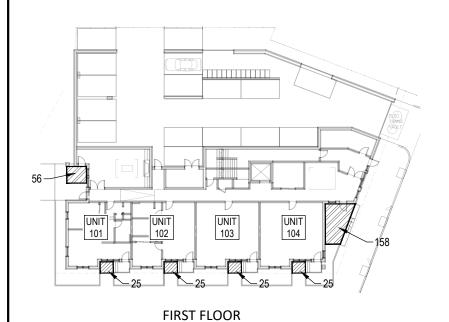

UNIT 211 UNIT 210 212 215 UNIT 🏗 UNIT UNIT 205 UNIT 201 202 204

SECOND to FOURTH FLOOR

NOTE - ALL BALCONIES MEET MINIMAL DIMENSIONAL REQUIREMENTS FOR 'BUILDING COMPONENTS: BALCONIES'

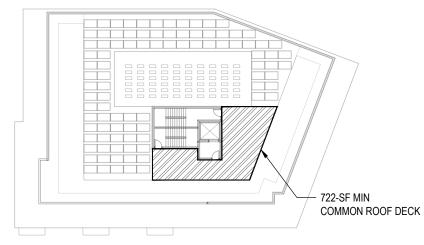

ROOF GARDEN LEVEL

504 UNIT 503 UNIT

UNIT 507

FIFTH FLOOR

PROVIDED (See Adjacent Table):

480-SF (PRIVATE) + 936-SF (COMMON) max to count toward OAS 1,416-SF TOTAL PROVIDED OAS

(Not including surplus provided.)

REQUIRED:

59 UNITS x 24-SF = 1,416-SF MIN OAS

NUMBER OF DWELLING UNITS WITHOUT PRIVATE OAS: 39 DUs. 39 DUs X 24 SF/DU = 936 SF TOTAL REQUIRED IN COMMON OAS. COMPLIES.

PRIVATE OUTDOOR AMENITY SPACE

= 2,663-SF total

(includes area exceeding minimum 24-sf/unit requirement)

COMMON OUTDOOR AMENITY SPACE = 936-SF total



| | REQUIRED | REQUIRED OAS | + EXCESS OAS | = TOTAL OAS |
|------------|----------|--------------|-------------------|-------------------|
| UNITS | OAS | PROVIDED | (>24-SF PER UNIT) | PROVIDED (PRIVATE |
| 101 | 24 | 24 | 1 | 25 |
| 102 | 24 | 24 | 1 | 25 |
| 103 | 24 | 24 | 1 | 25 |
| 104 | 24 | 24 | 1 | 25 |
| 201 | 24 | 0 | 0 | 0 |
| 202 | 24 | 0 | 0 | 0 |
| 203 | 24 | 0 | 0 | 0 |
| 204 205 | 24 24 | 0 24 | 0 25 | 0 49 |
| 205 | 24 | 24 | 28 | 52 |
| 207 | 24 | 24 | 28 | 52 |
| 208 | 24 | 0 | 0 | 0 |
| 209 | 24 | 0 | 0 | 0 |
| 210 | 24 | 0 | 0 | 0 |
| 211 | 24 | 0 | 0 | 0 |
| 212 | 24 | 0 | 0 | 0 |
| 213 | 24 | 0 | 0 | 0 |
| 214 | 24 | 0 | 0 | 0 |
| 215 | 24 | 0 | 0 | 0 |
| 301 302 | 24 24 | 0 | 0 | 0 |
| 303 | 24 | 0 | 0 | 0 |
| 304 | 24 | 0 | 0 | 0 |
| 305 | 24 | 24 | 25 | 49 |
| 306 | 24 | 24 | 28 | 52 |
| 307 | 24 | 24 | 28 | 52 |
| 308 | 24 | 0 | 0 | 0 |
| 309 | 24 | 0 | 0 | 0 |
| 310 | 24 | 0 | 0 | 0 |
| 311 | 24 | 0 | 0 | 0 |
| 312 | 24 | 0 | 0 | 0 |
| 313 314 | 24 24 | 0 | 0 | 0 |
| 315 | 24 | 0 | 0 | 0 |
| 401 | 24 | 0 | 0 | 0 |
| 402 | 24 | 0 | 0 | 0 |
| 403 | 24 | 0 | 0 | 0 |
| 404 | 24 | 0 | 0 | 0 |
| 405 | 24 | 24 | 25 | 49 |
| 406 | 24 | 24 | 28 | 52 |
| 407 | 24 | 24 | 28 | 52 |
| 408 | 24 | 0 | 0 | 0 |
| 409 | 24 | 0 | 0 | 0 |
| 410 411 | 24 24 | 0 | 0 | 0 |
| 411 | 24 | 0 | 0 | 0 |
| 413 | 24 | 0 | 0 | 0 |
| 414 | 24 | 0 | 0 | 0 |
| 415 | 24 | 0 | 0 | 0 |
| 501 | 24 | 24 | 511 | 535 |
| 502 | 24 | 24 | 175 | 199 |
| 503 | 24 | 24 | 456 | 480 |
| 504 | 24 | 24 | 185 | 209 |
| 505 | 24 | 24 | 197 | 221 |
| 506 | 24 | 0 | 0 | 0 |
| 507 | 24 | 0 | 0 | 0 |
| 508 509 | 24 24 | 0 24 | 0 246 | 0 270 |
| 510 | 24 | 24 | 166 | 190 |
| | | | | |
| TOTAL | 1,416 | 480 | 2,183 | 2,663 |

PLANNING

PETER QUINN ARCHITECTS LLC 259 ELM STREET, SUITE 301 SOMERVILLE, MA 02144 PH 617-354-3989



3 HAWKINS ST

3 HAWKINS ST. SOMERVILLE, MA 02143

PREPARED FOR

HAWKINS STREET UNION SQ LLC

7 MORRISON RD WEST WAKEFIELD, MA 01880

DRAWING TITLE

ZONING COMPLIANCE (OUTDOOR AMENITY SPACE)

SCALE AS NOTED

| REVISION | DATE |
|-----------|-------------|
| | |
| DRA REV-3 | 8 APR 2021 |
| DRA REV-2 | 28 JAN 2021 |
| DRA REV-1 | 23 OCT 2020 |

14 JUL 2020

DRA APPL









ARCHITECTURE
PLANNING
COMMUNITY DESIG

PETER QUINN ARCHITECTS LLC 259 ELM STREET, SUITE 301 SOMERVILLE, MA 02144 PH 617-354-3989



CONSULTANT









3 HAWKINS ST

3 HAWKINS ST. SOMERVILLE, MA 02143

PREPARED FOR

HAWKINS STREET UNION SQ LLC

7 MORRISON RD WEST WAKEFIELD, MA 01880

DRAWING TIT

EXISTING CONDITIONS PHOTOS

SCALE AS NOTED

| REVISION | DATE |
|-----------|--------------|
| | |
| DRA REV-3 | 08 APR 2021 |
| DRA REV-2 | 28 JAN 2021 |
| DRA REV-1 | 23 OCT 2020 |
| DRA APPL | 14 JULY 2020 |
| DRAWN BY | REVIEWED BY |
| MN / YC | PQ |
| 011555 | |

= (, _ ′

QUINN ARCH TECTS

ARCHITECTURE
PLANNING
OMMUNITY DESIGN

PETER QUINN ARCHITECTS LLC 259 ELM STREET, SUITE 301 SOMERVILLE, MA 02144

SEAL STERED ARCHIVES SAMUER OF CAMBRIDGE SAMUER OF MASSIVER OF MAS

CONSULTANT

PROJECT

3 HAWKINS ST

3 HAWKINS ST. SOMERVILLE, MA 02143

PREPARED FOR

HAWKINS STREET UNION SQ LLC

7 MORRISON RD WEST WAKEFIELD, MA 01880

DRAWING TITLE

AERIAL VIEW FROM WEST

SCALE AS NOTED

| KEVISION | DATE |
|-----------|------------|
| | |
| DRA REV-3 | 08 APR 202 |
| DRA REV-2 | 28 JAN 202 |
| DRA REV-1 | 23 OCT 202 |

DRA APPL 14 JULY 2020

DRAWN BY REVIEWED BY PQ

YC PQ

SHEET

PLANNING COMMUNITY DESIGN

PETER QUINN ARCHITECTS LLC 259 ELM STREET, SUITE 301 SOMERVILLE, MA 02144 PH 617-354-3989



CONSULTANT

ROJECT

3 HAWKINS ST

3 HAWKINS ST. SOMERVILLE, MA 02143

PREPARED FOR

HAWKINS STREET UNION SQ LLC

7 MORRISON RD WEST WAKEFIELD, MA 01880

DRAWING TITLE

STREET VIEW @ LAKE ST

SCALE AS NOTED

| REVISION | DATE |
|----------------|--------------|
| | |
| DRA REV-3 | 08 APR 2021 |
| DRA REV-2 | 28 JAN 2021 |
| DRA REV-1 | 23 OCT 2020 |
| DRA APPL | 14 JULY 2020 |
| DRAWN BY YC | REVIEWED BY |
| | |

SHEET

PETER QUINN ARCH TECTS

PLANNING
COMMUNITY DESIGN

PETER QUINN ARCHITECTS LLC 259 ELM STREET, SUITE 301 SOMERVILLE, MA 02144 PH 617-354-3989

SEAL



CONSULTA

ROJECT

3 HAWKINS ST

3 HAWKINS ST. SOMERVILLE, MA 02143

PREPARED FOR

HAWKINS STREET UNION SQ LLC

7 MORRISON RD WEST WAKEFIELD, MA 01880

DRAWING TITLE

STREET VIEW @ HAWKINS ST CORNER

SCALE AS NOTED

| | REVISION | DATE |
|---|-----------|--------------|
| | | |
| | DRA REV-3 | 08 APR 2021 |
| | DRA REV-2 | 28 JAN 2021 |
| | DRA REV-1 | 23 OCT 2020 |
| | DRA APPL | 14 JULY 2020 |
| / | DRAWN BY | REVIEWED BY |

SHEET

PETER QUINN ARCHI TECTS

ARCHITECTURE
PLANNING
COMMUNITY DESIGN

PETER QUINN ARCHITECTS LLC 259 ELM STREET, SUITE 301 SOMERVILLE, MA 02144 PH 617-354-3989

SEAL



CONSULTAL

PROJECT

3 HAWKINS ST

3 HAWKINS ST. SOMERVILLE, MA 02143

PREPARED FOR

HAWKINS STREET UNION SQ LLC

7 MORRISON RD WEST WAKEFIELD, MA 01880

DRAWING TITLE

STREET VIEW @ HAWKINS ST

SCALE AS NOTED

| | REVISION | DATE |
|----|-----------|-------------|
| | | |
| | DRA REV-3 | 08 APR 202 |
| | DRA REV-2 | 28 JAN 202 |
| _ | DRA REV-1 | 23 OCT 202 |
| ١, | DRA APPL | 14 JULY 202 |
| | DDAWN DV | DEVIEWED DY |

SHEET

QUINN ARCHI TECTS

ARCHITECTURE
PLANNING
COMMUNITY DESIGN

PETER QUINN ARCHITECTS LLC 259 ELM STREET, SUITE 301 SOMERVILLE, MA 02144 PH 617-354-3989

SEAL SERIED ARCHIVES AMULE OF THE SEAL OF

CONSULTA

ROJECT

3 HAWKINS ST

3 HAWKINS ST. SOMERVILLE, MA 02143

PREPARED FOR

HAWKINS STREET UNION SQ LLC

7 MORRISON RD WEST WAKEFIELD, MA 01880

DRAWING TITLE

STREET VIEW @ SOMERVILLE AVE


SCALE AS NOTED


| REVISION | DATE |
|------------|------------|
| | |
| DRA REV-3 | 08 APR 202 |
| DRA REV-2 | 28 JAN 202 |
| DDA DEV/ 1 | 22 OCT 202 |

DRA APPL 14 JULY 2020

DRAWN BY REVIEWED BY YC PQ

SHEET

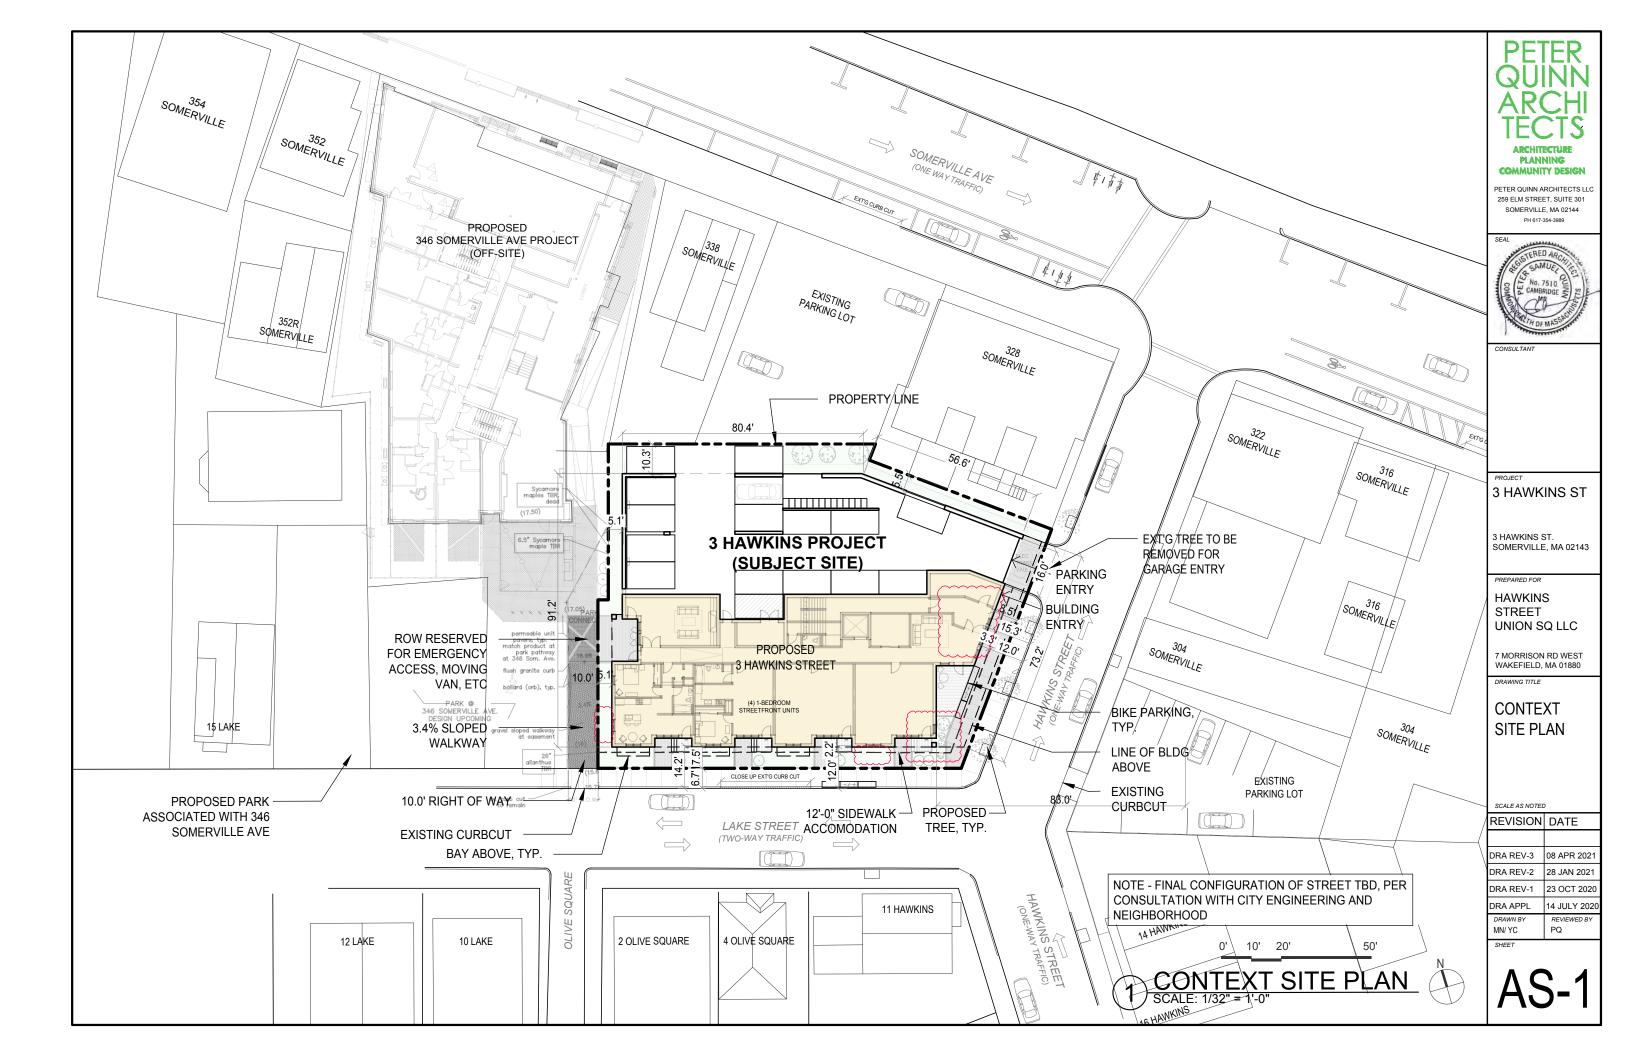

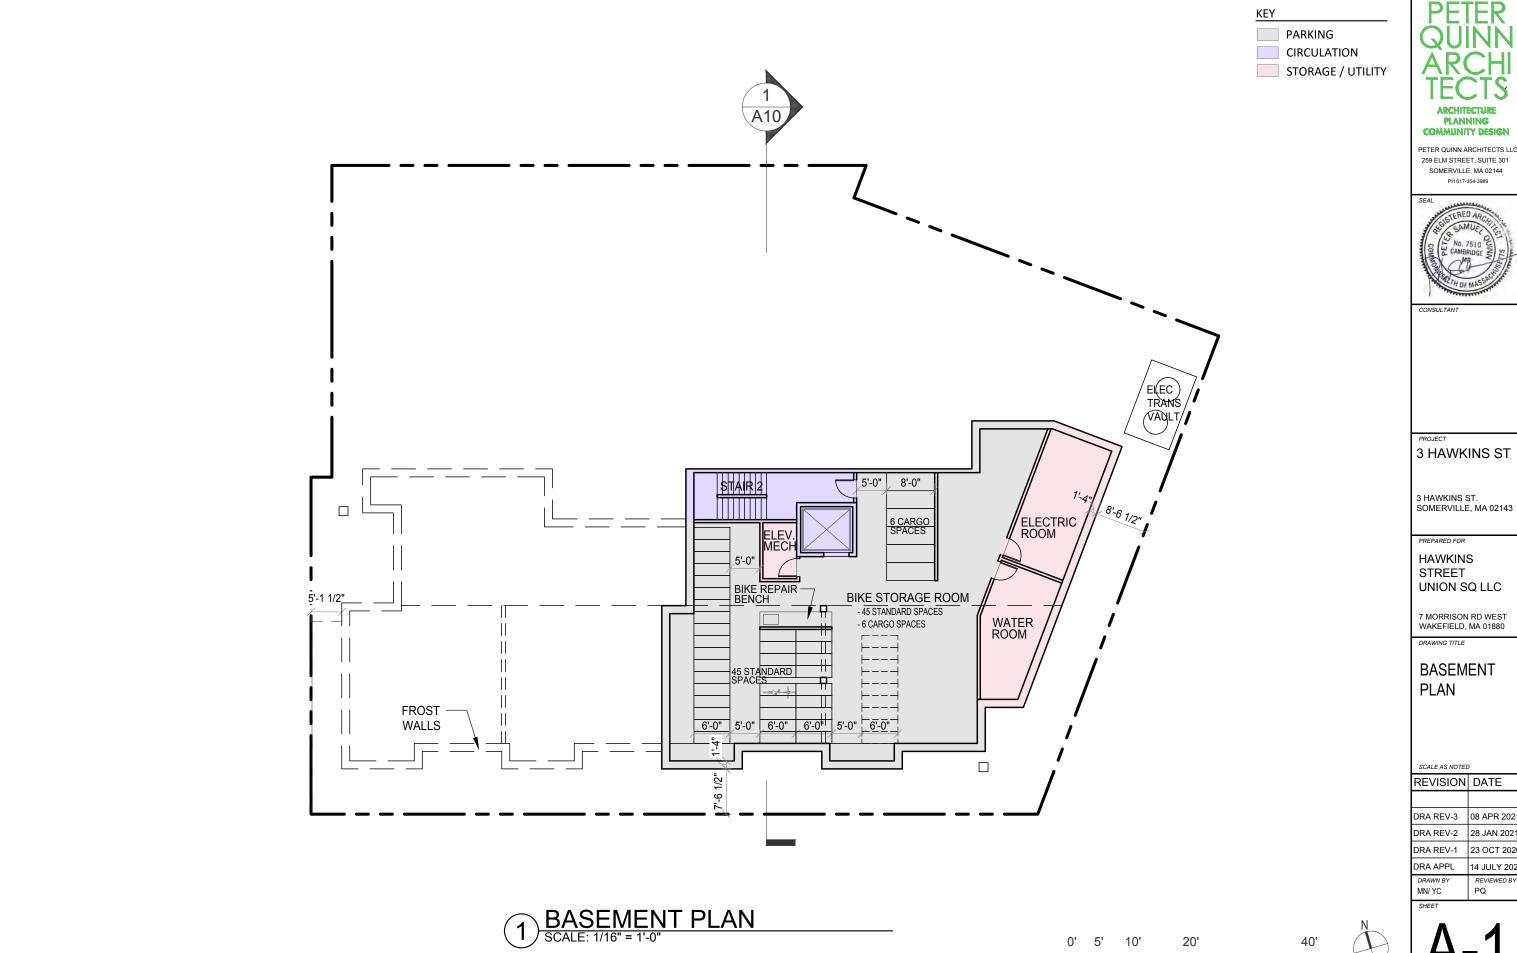

PLANNING COMMUNITY DESIGN

259 ELM STREET, SUITE 301 SOMERVILLE, MA 02144 PH 617-354-3989



3 HAWKINS ST

3 HAWKINS ST. SOMERVILLE, MA 02143

PREPARED FOR

HAWKINS STREET UNION SQ LLC

7 MORRISON RD WEST WAKEFIELD, MA 01880


DRAWING TITLE

BASEMENT PLAN

SCALE AS NOTED

| DRA REV-3 | 08 APR 202 |
|-----------|------------|
| DRA REV-2 | 28 JAN 202 |
| DRA REV-1 | 23 OCT 202 |
| | |

DRA APPL 14 JULY 2020 MN/ YC PQ

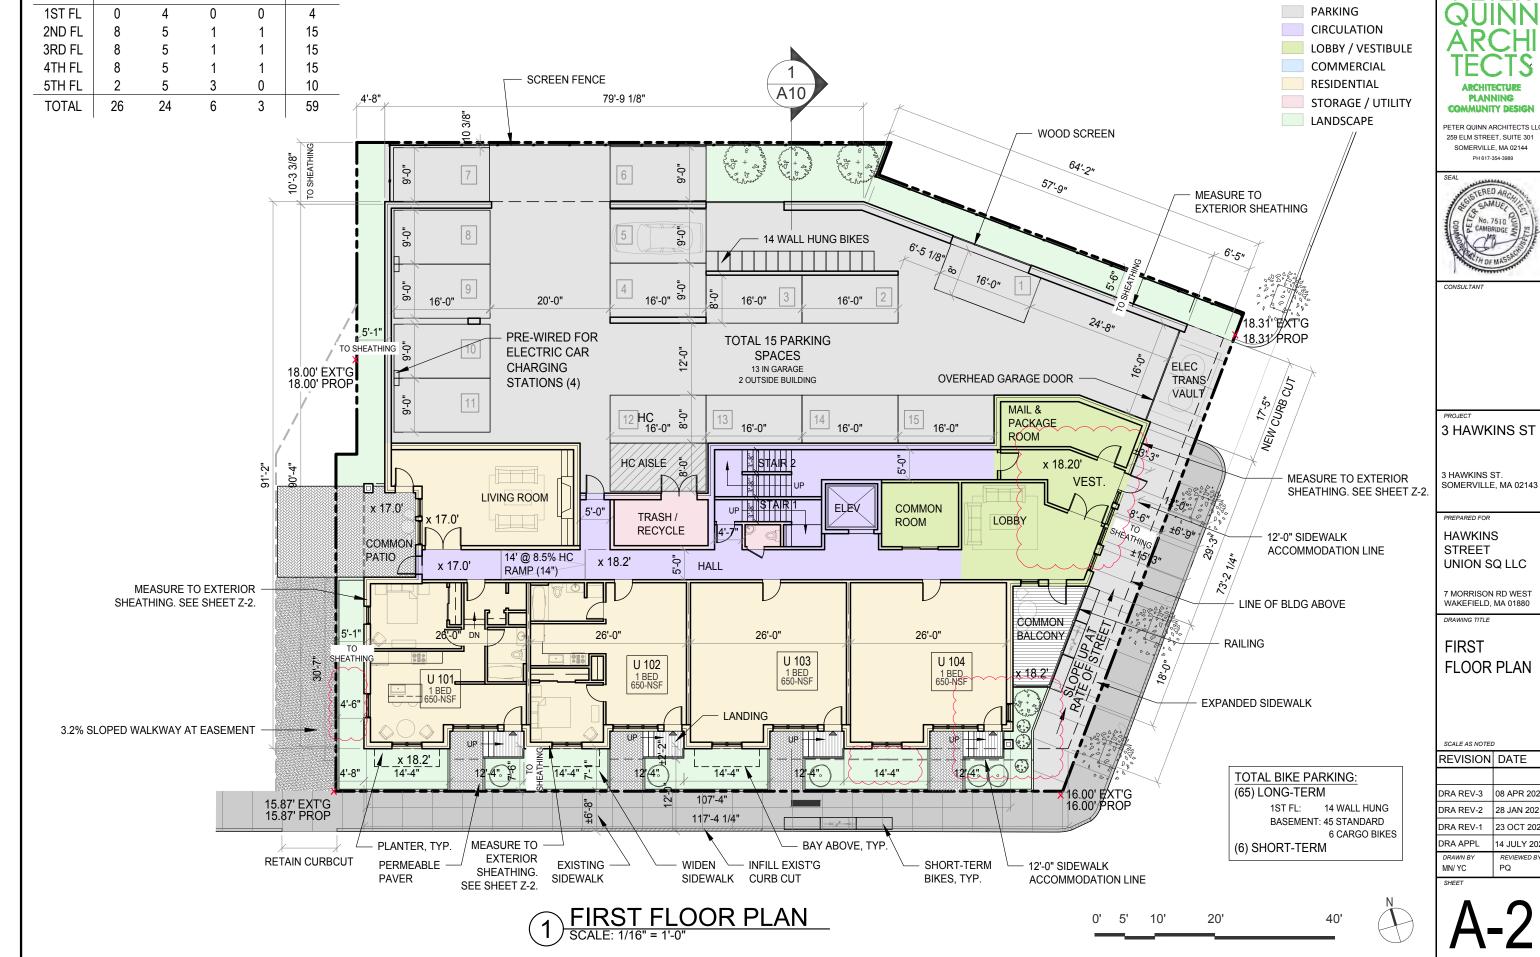

KEY

PETER QUINN ARCHITECTS LLC 259 ELM STREET, SUITE 301 SOMERVILLE, MA 02144



7 MORRISON RD WEST

FLOOR PLAN


| DRA REV-3 | 08 APR 2021 |
|-----------|-------------|
| DRA REV-2 | 28 JAN 2021 |
| | |

DRA REV-1 23 OCT 2020 14 JULY 202 REVIEWED B

FLOOR

STUDIO 1-BED 2-BED 3-BED

TOTAL

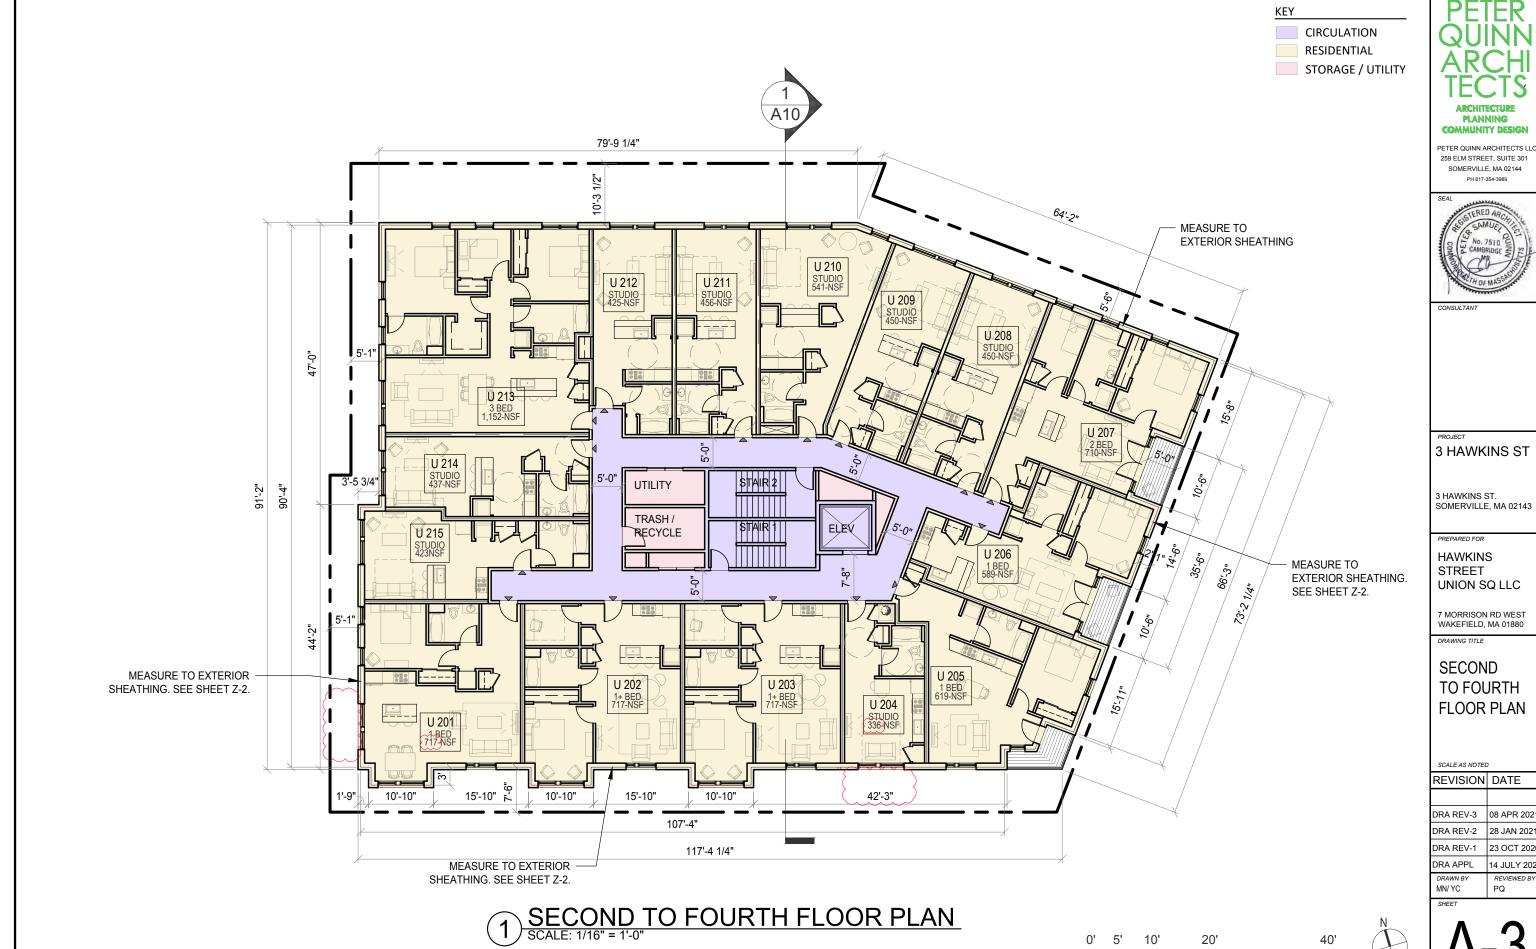

PLANNING **COMMUNITY DESIGN**

259 ELM STREET, SUITE 301 SOMERVILLE, MA 02144 PH 617-354-3989



3 HAWKINS ST

3 HAWKINS ST. SOMERVILLE, MA 02143

PREPARED FOR

HAWKINS STREET UNION SQ LLC


7 MORRISON RD WEST WAKEFIELD, MA 01880

DRAWING TITLE

SECOND TO FOURTH FLOOR PLAN

SCALE AS NOTED

| | י כ |
|-----------|-------------|
| | |
| DRA REV-3 | 08 APR 202 |
| DRA REV-2 | 28 JAN 202 |
| DRA REV-1 | 23 OCT 202 |
| DRA APPL | 14 JULY 202 |
| DRAWN BY | REVIEWED BY |
| MN/ YC | PQ |

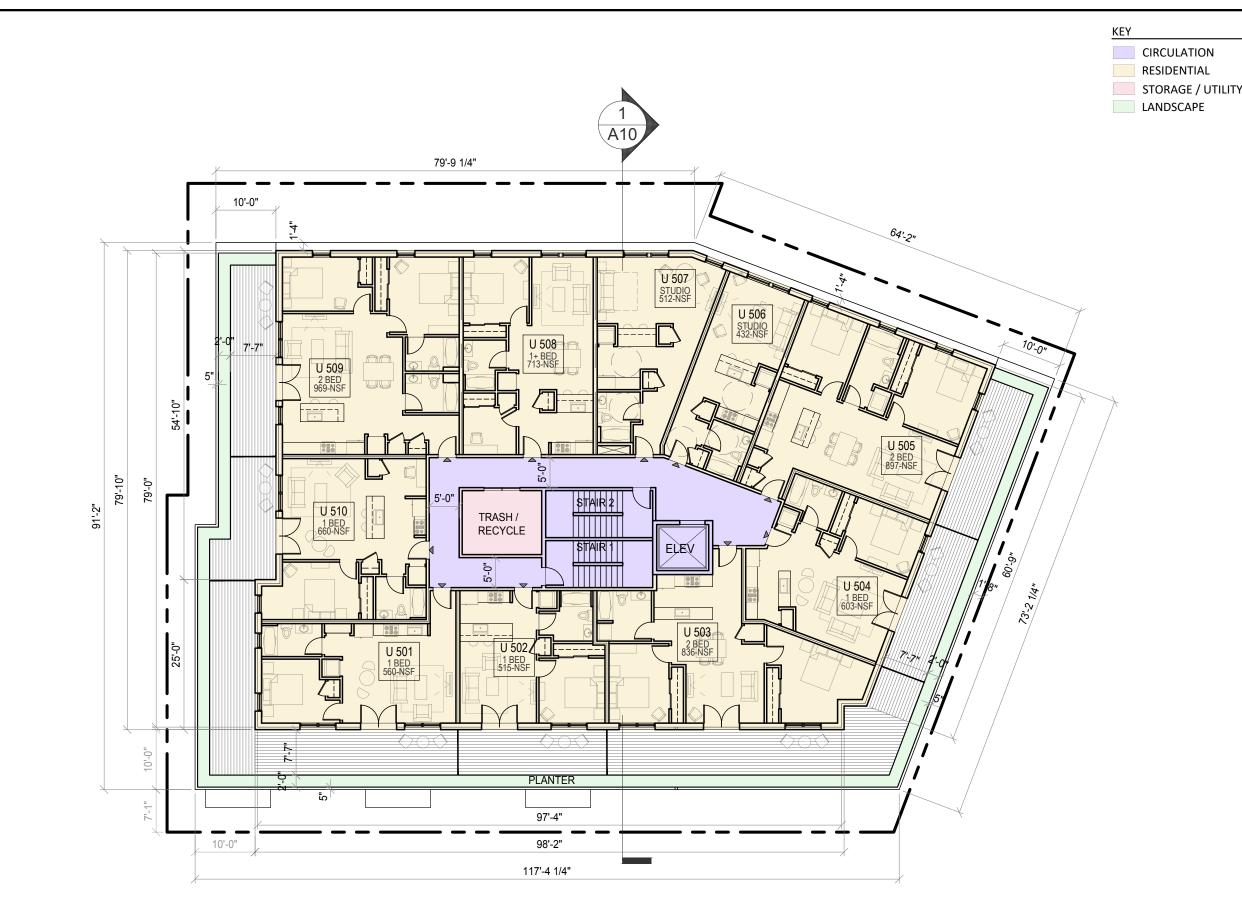

1 FIFTH FLOOR PLAN SCALE: 1/16" = 1'-0"

0' 5' 10' 20' 40





ARCHITECTURE
PLANNING
COMMUNITY DESIGN

PETER QUINN ARCHITECTS LLC 259 ELM STREET, SUITE 301 SOMERVILLE, MA 02144 PH 617-354-3989

SEAL SERED ARCHIVES SAMUE OF THE OF MASSING

CONSULTA

PROJECT

3 HAWKINS ST

3 HAWKINS ST. SOMERVILLE, MA 02143

PREPARED FOR

HAWKINS STREET UNION SQ LLC

7 MORRISON RD WEST WAKEFIELD, MA 01880

DRAWING TITLE


FIFTH FLOOR PLAN

SCALE AS NOTED

| REVISION | DATE |
|--------------------|-------------------|
| | |
| DRA REV-3 | 08 APR 202 |
| DRA REV-2 | 28 JAN 2021 |
| DRA REV-1 | 23 OCT 2020 |
| DRA APPL | 14 JULY 202 |
| DRAWN BY MN/ YC | REVIEWED BY PQ |

SHEET

A-4

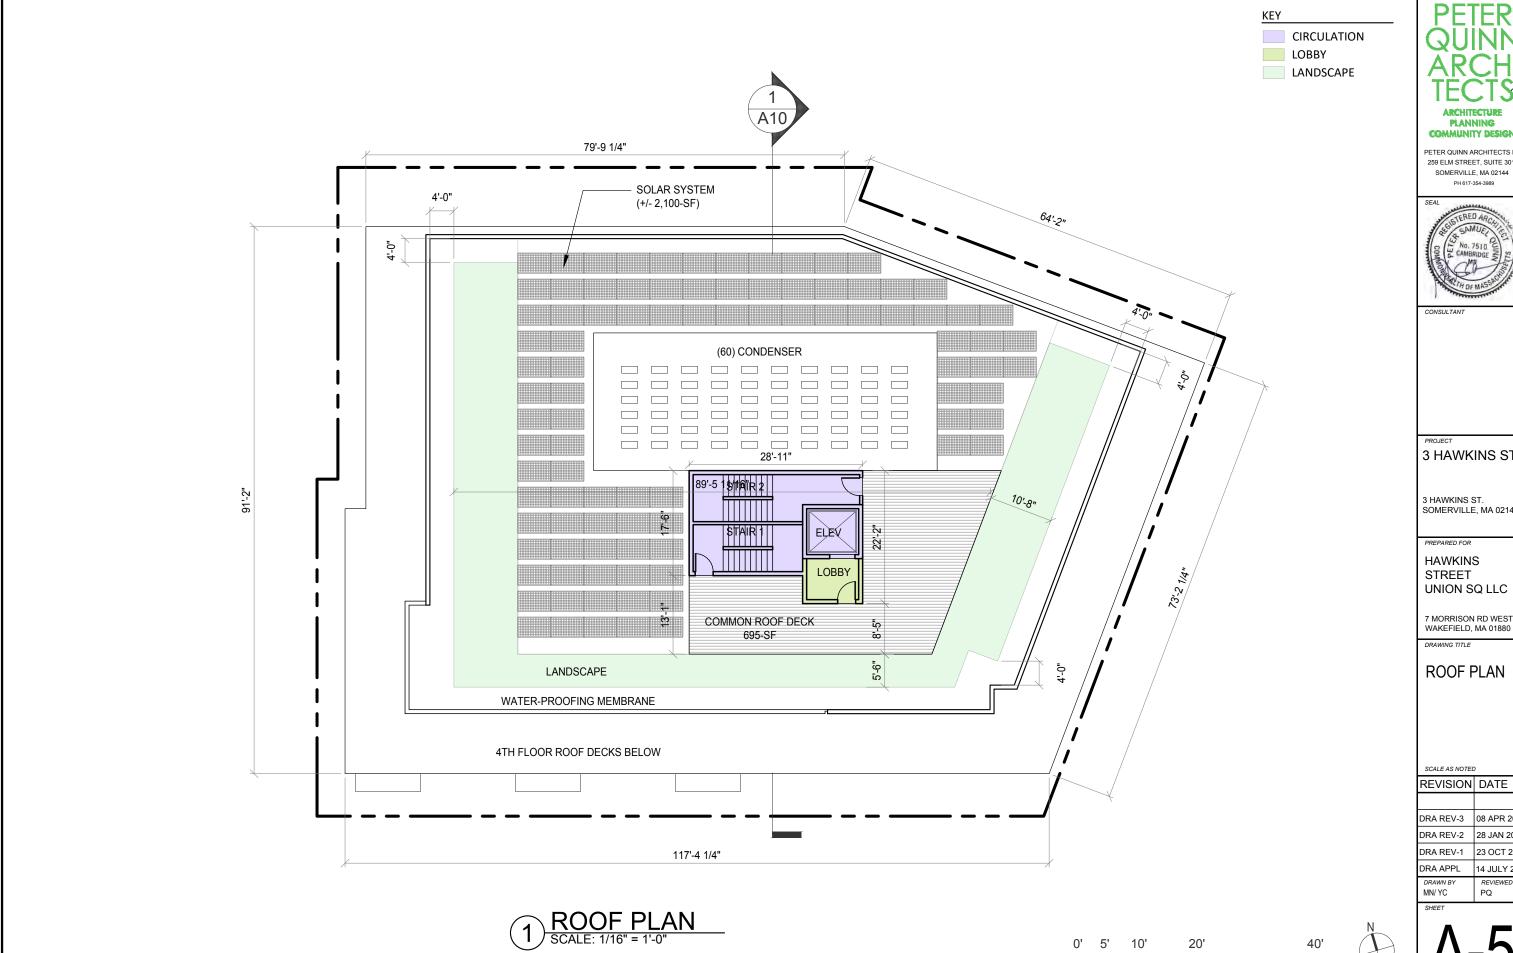

PLANNING **COMMUNITY DESIGN**

PETER QUINN ARCHITECTS LLC 259 ELM STREET, SUITE 301 SOMERVILLE, MA 02144 PH 617-354-3989



3 HAWKINS ST

3 HAWKINS ST. SOMERVILLE, MA 02143

PREPARED FOR

HAWKINS STREET UNION SQ LLC

7 MORRISON RD WEST WAKEFIELD, MA 01880

DRAWING TITLE

ROOF PLAN

SCALE AS NOTED


| DRA REV-3 | 08 APR 20 |
|-----------|-----------|
| DRA REV-2 | 28 JAN 20 |
| | |

DRA REV-1 23 OCT 2020 14 JULY 2020 PQ



PARK ELEVATION
SCALE: 3/32" = 1'-0"

A-9

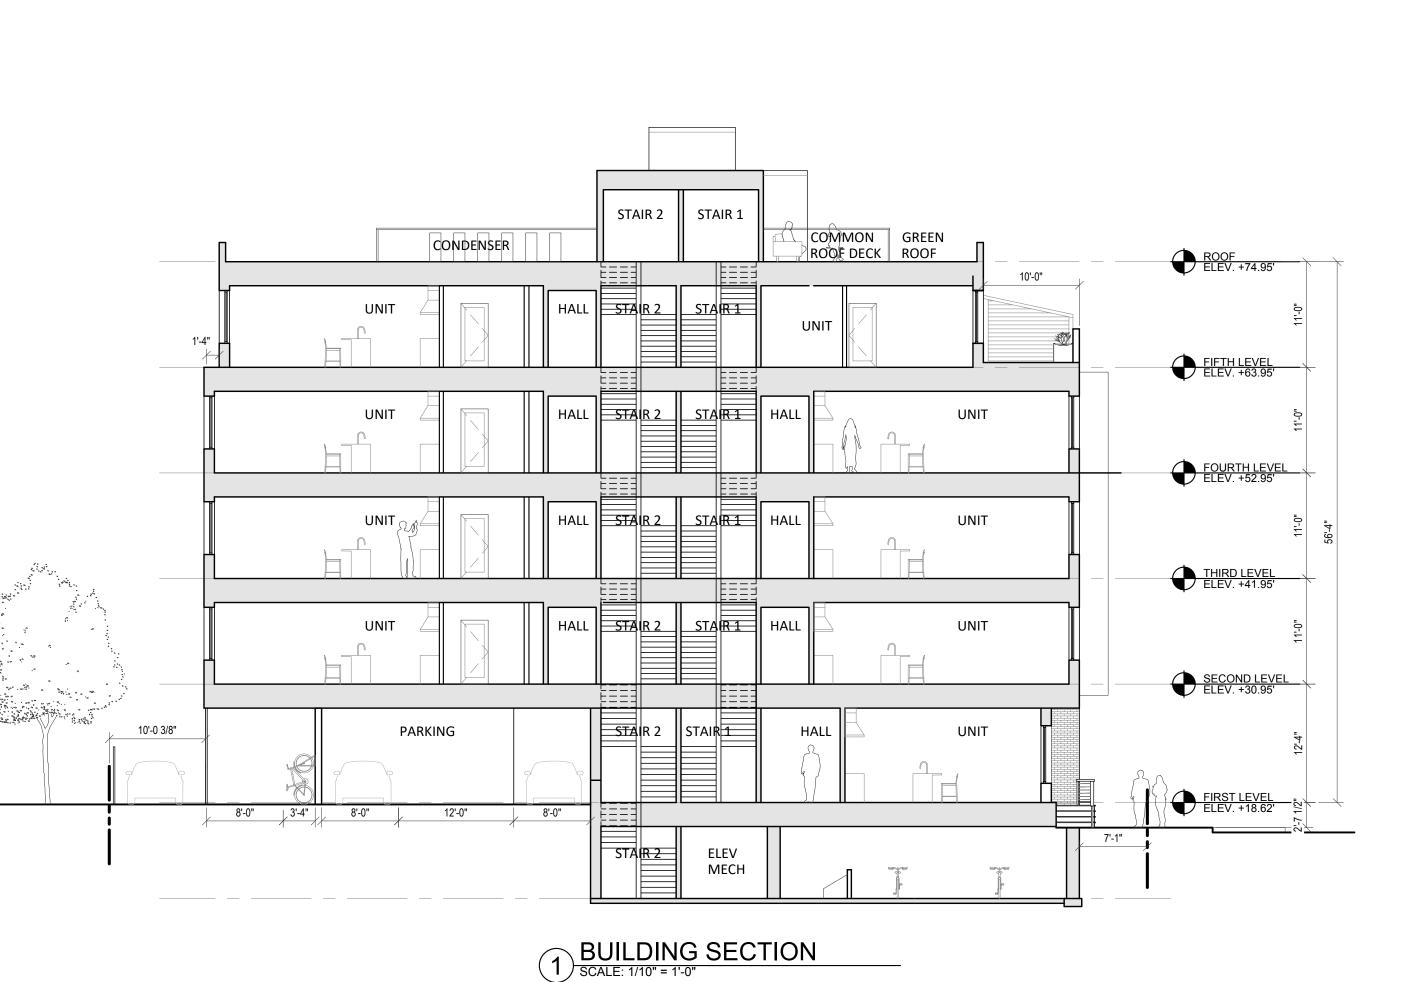

PETER QUINN ARCHI TECTS

PLANNING
COMMUNITY DESIGN

PETER QUINN ARCHITECTS LLC 259 ELM STREET, SUITE 301 SOMERVILLE, MA 02144 PH 617-354-3989



CONSULTAN

3 HAWKINS ST

3 HAWKINS ST. SOMERVILLE, MA 02143

PREPARED FOR

HAWKINS STREET UNION SQ LLC

7 MORRISON RD WEST WAKEFIELD, MA 01880

DRAWING TITLE

BUILDING SECTION

SCALE AS NOTED

| REVISION | DATE |
|-----------|-----------|
| | |
| DRA REV-3 | 08 APR 20 |

DRA REV-2 28 JAN 2021
DRA REV-1 23 OCT 2020
DRA APPL 14 JULY 2020
DRAWN BY REVIEWED BY PQ

SHEET

A-10





1 FIBER CEMENT TRIM - SMOOTH, PAINTED

4 FIBER CEMENT LAP SIDING
- 11" EXPOSURE
- SMOOTH, PAINTED



2 FIBER CEMENT LAP SIDING - 5" EXPOSURE

- SMOOTH, PAINTED





METAL CORNER TRIM - PAINTED



FIBER CEMENT PANELS - SMOOTH, PAINTED



7 MORRISON RD WEST WAKEFIELD, MA 01880





10 FIBER CEMENT LAP SIDING - 4.5" EXPOSURE - SMOOTH, PAINTED



CASEMENT **WINDOWS**



FULL-BED BRICK #2 W COLORED MORTAR



DRA REV-1 23 OCT 2020 ORA APPL 14 JULY 202 REVIEWED BY PQ

08 APR 202

28 JAN 2021

PLANNING

PETER QUINN ARCHITECTS LLC 259 ELM STREET, SUITE 301 SOMERVILLE, MA 02144 PH 617-354-3989

3 HAWKINS ST

SOMERVILLE. MA 02143

3 HAWKINS ST.

PREPARED FOR **HAWKINS** STREET UNION SQ LLC

DRAWING TITLE

TYPICAL EXTERIOR

SCALE AS NOTED


DRA REV-3

DRA REV-2

REVISION DATE

MATERIALS



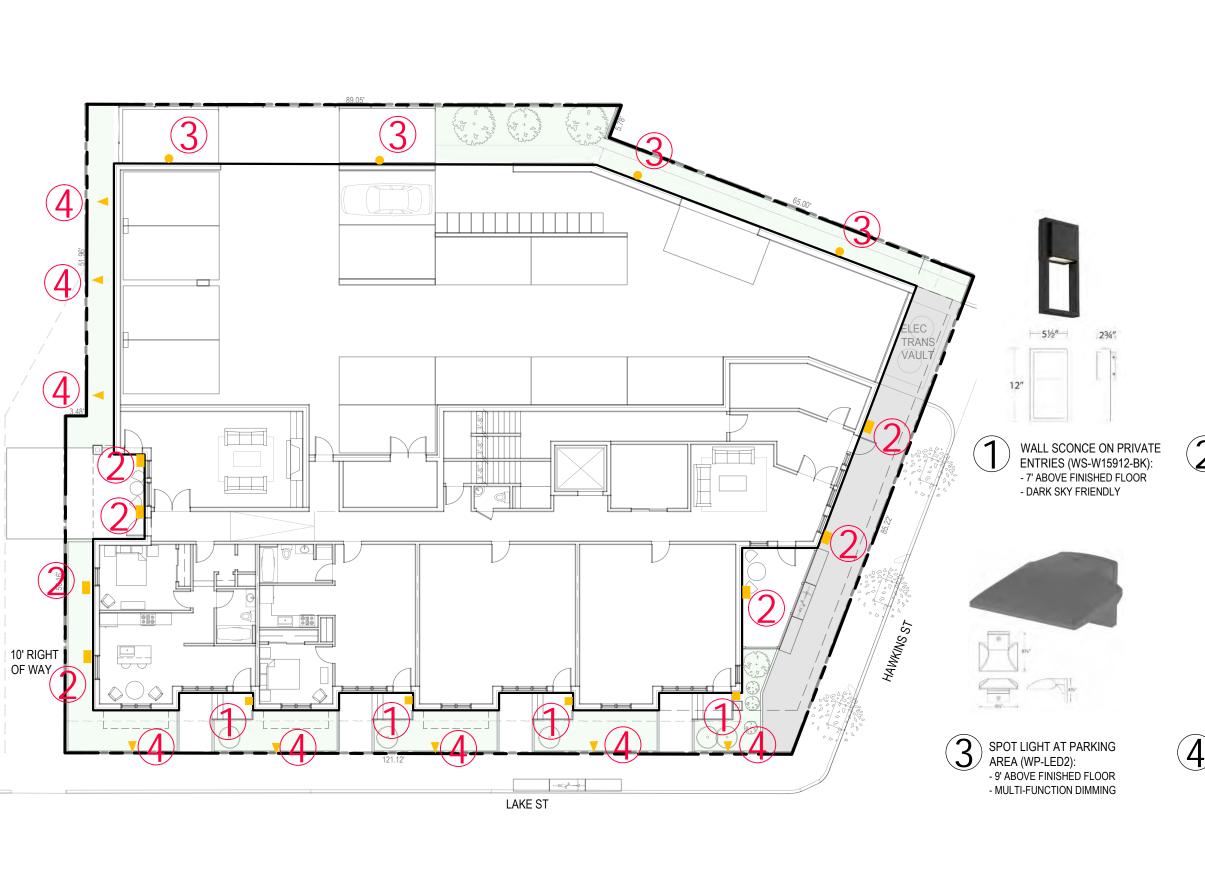



WALL SCONCE ON COMMON AREAS (WP-LED1, BRONZE):
- 7' ABOVE FINISHED FLOOR

- MULTI-FUNCTION DIMMING



SPOT LIGHT ON LANDSCAPE (ACCENT 5012):
- ON GRADE, ADJUSTABLE &

LOCKABLE BEAM ANGLE - INTEGRAL DIMMER PETER QUINN ARCHI TECTS ARCHITECTURE

PETER QUINN ARCHITECTS LLC 259 ELM STREET, SUITE 301 SOMERVILLE, MA 02144 PH 617-354-3989

PLANNING COMMUNITY DESIGN



CONSULTANT

PROJECT

3 HAWKINS ST

3 HAWKINS ST. SOMERVILLE, MA 02143

PREPARED FOR

HAWKINS STREET UNION SQ LLC

7 MORRISON RD WEST WAKEFIELD, MA 01880

DRAWING TITLE

EXTERIOR LIGHTING PLAN

SCALE AS NOTED

| REVISION | DATE |
|----------------|-------------------|
| | |
| DRA REV-3 | 08 APR 2021 |
| DRA REV-2 | 28 JAN 2021 |
| DRA REV-1 | 23 OCT 2020 |
| DRA APPL | 14 JULY 2020 |
| DRAWN BY YC | REVIEWED BY PQ |

SHEET

A-12





3 HAWKINS - SHADOW STUDY


SOMERVILLE, MASSACHUSETTS






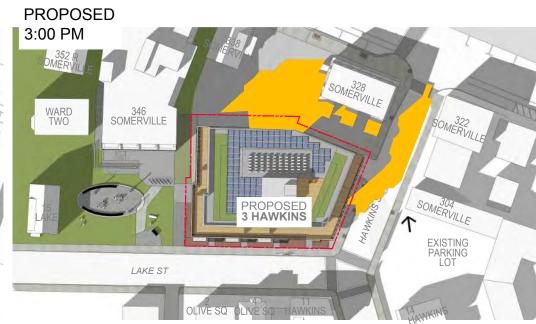

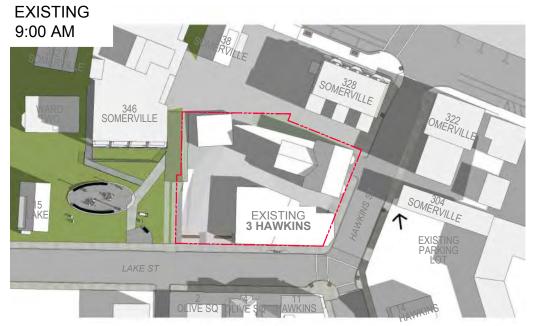

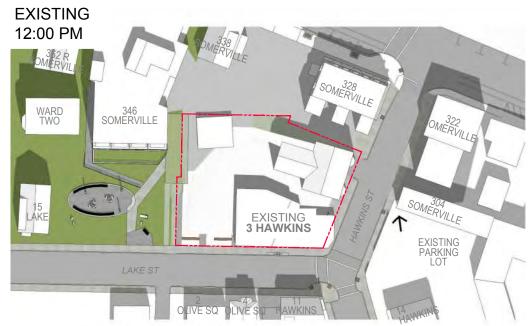

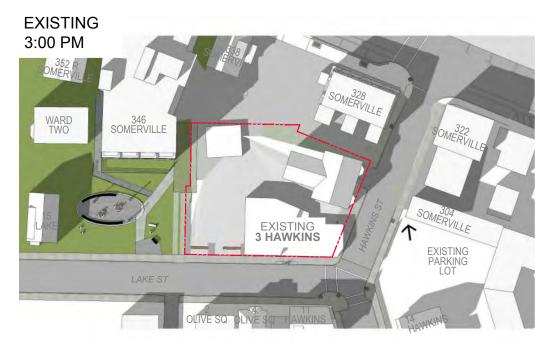

ADDITIONAL SHADOW






3 HAWKINS - SHADOW STUDY

SOMERVILLE, MASSACHUSETTS






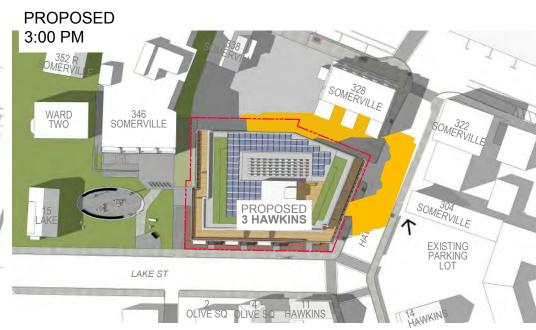





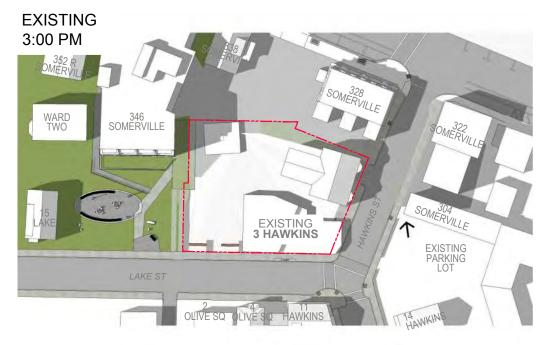

ADDITIONAL SHADOW






3 HAWKINS - SHADOW STUDY


SOMERVILLE, MASSACHUSETTS






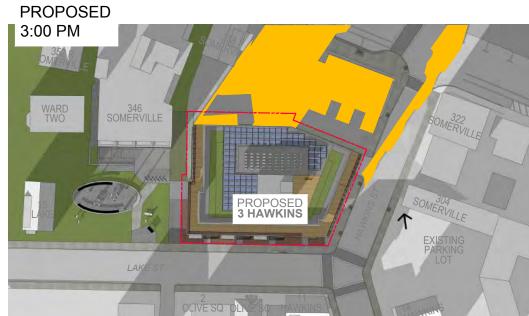



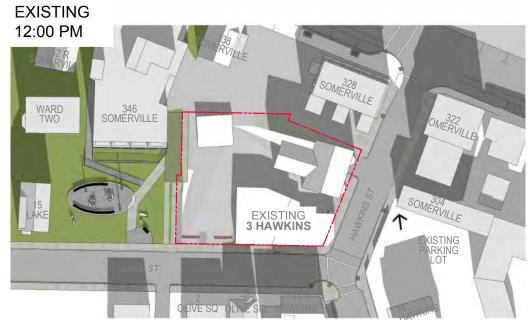


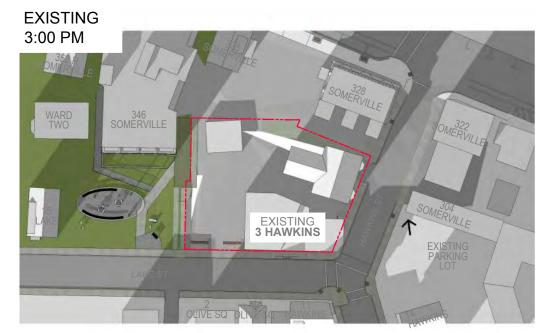

ADDITIONAL SHADOW





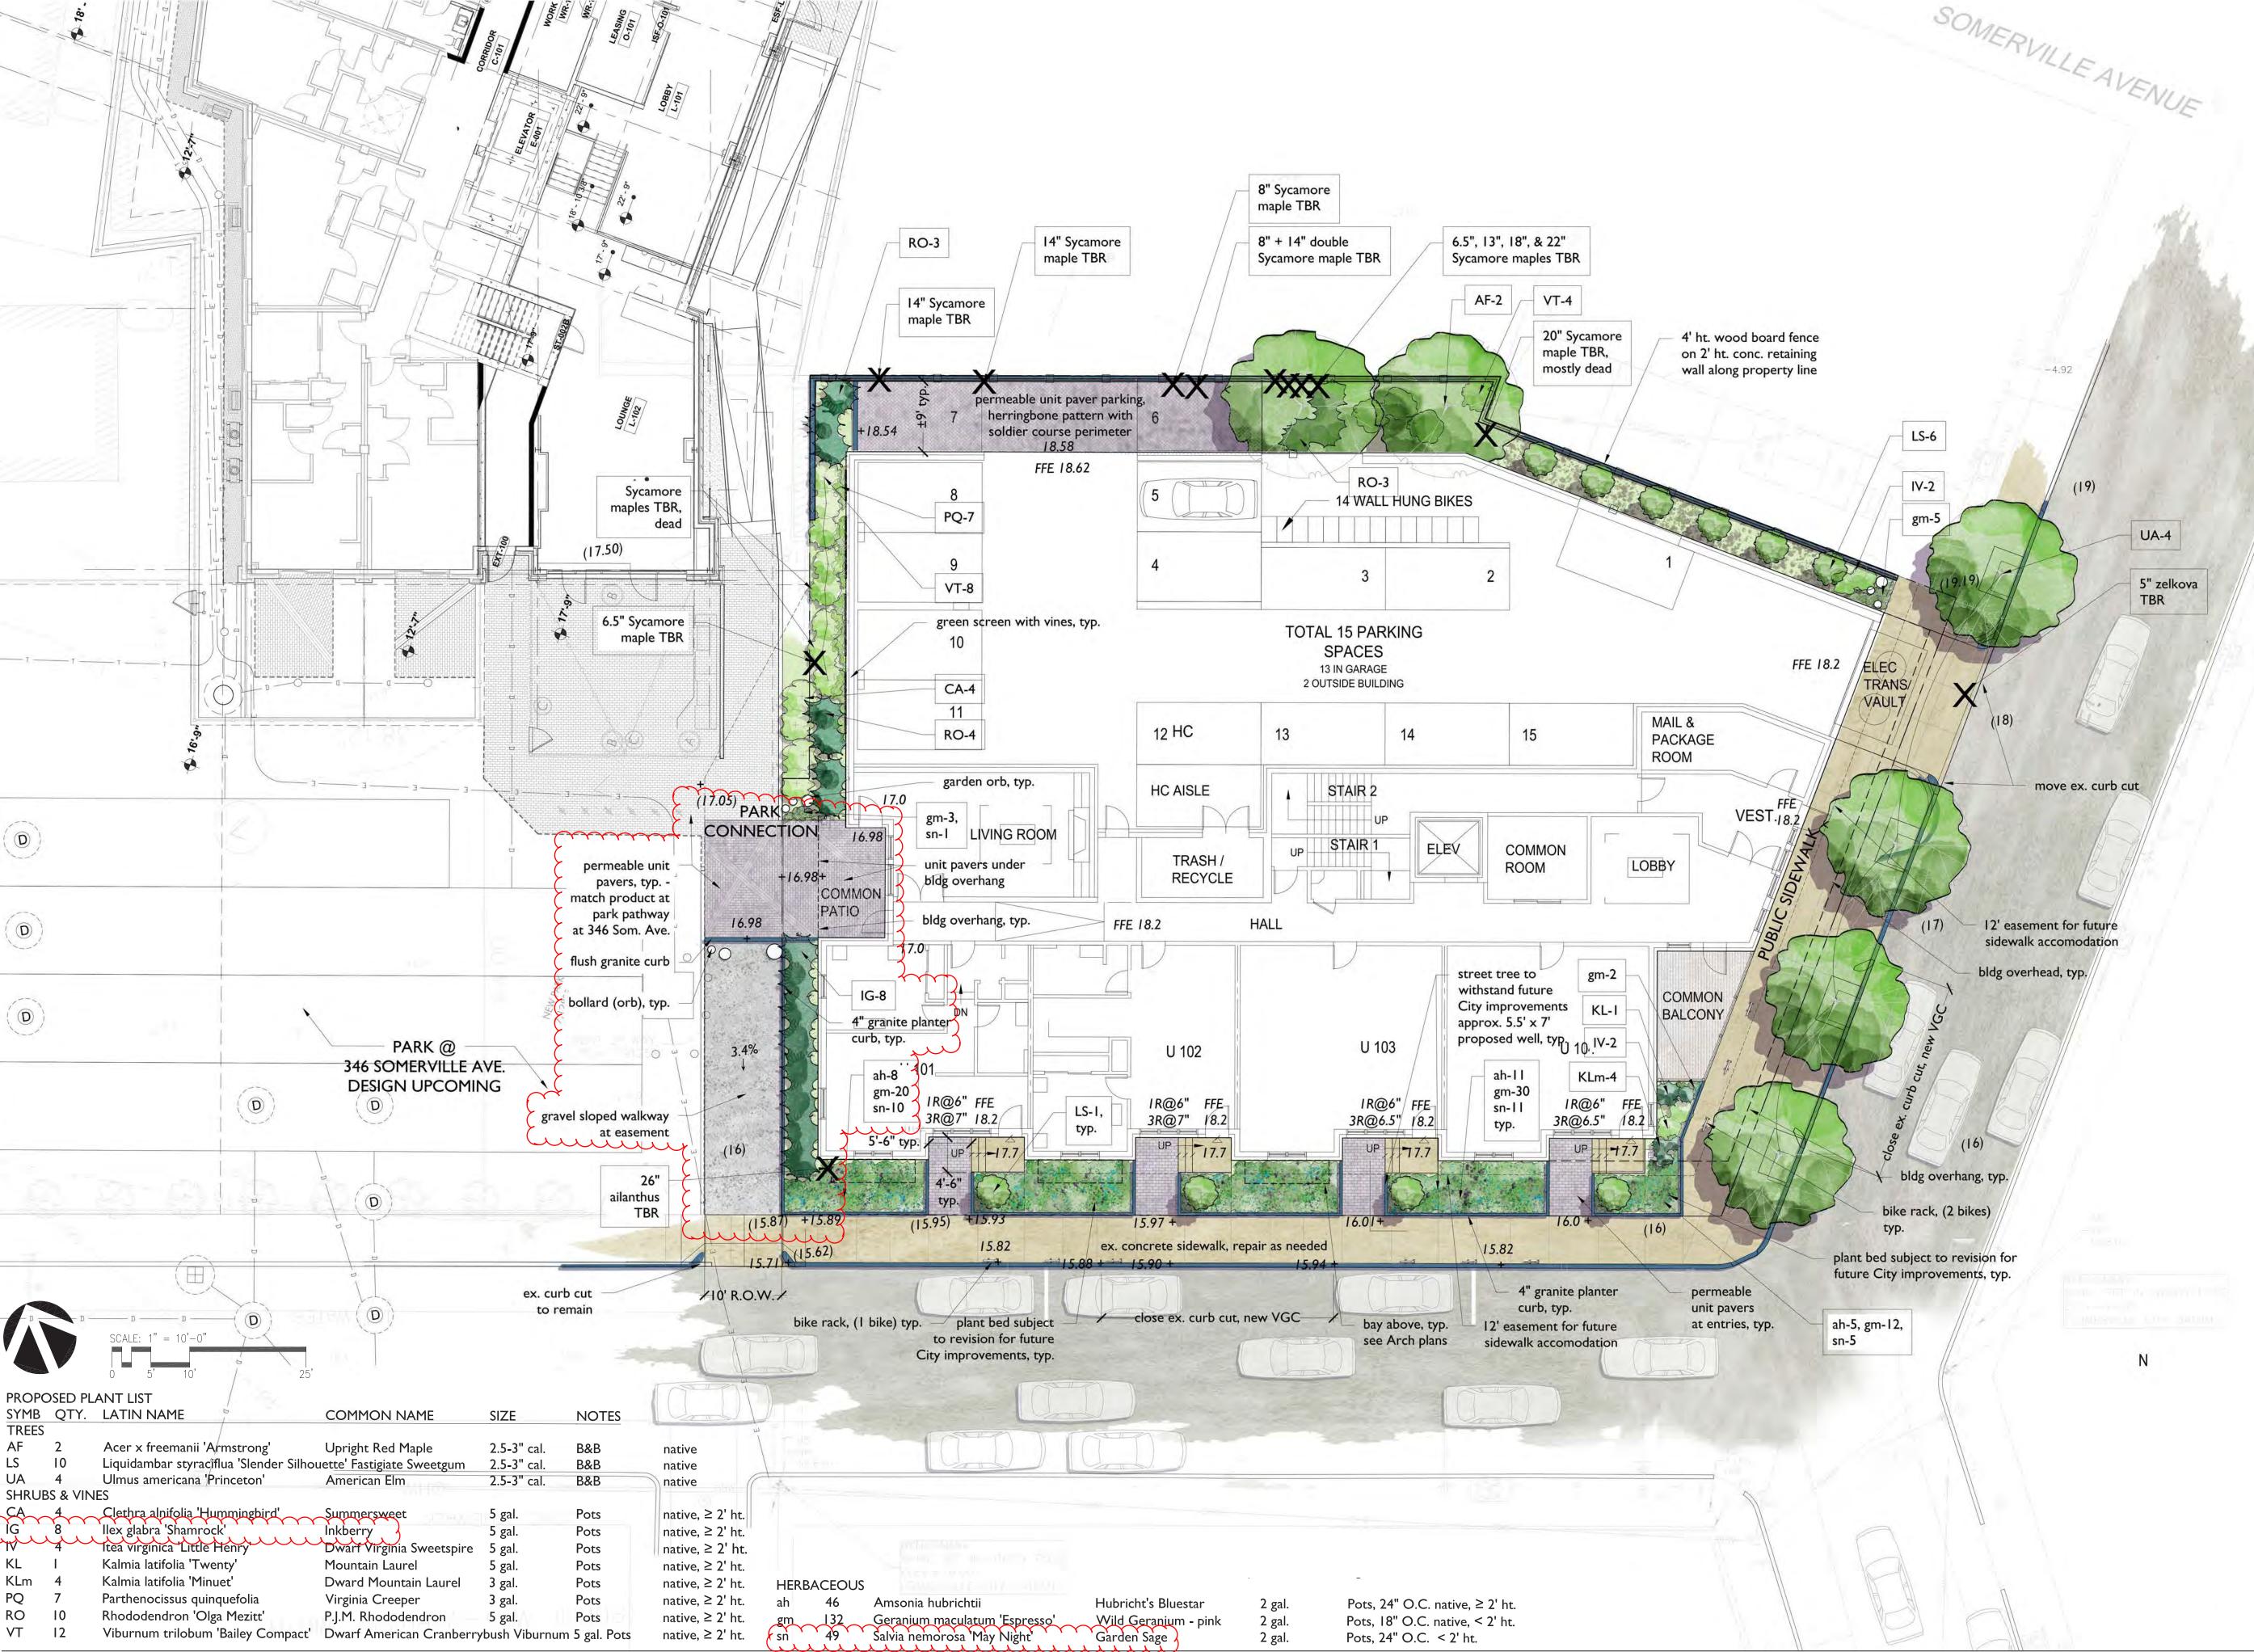



Concrete Garden Orbs - to match 346 Somerville Ave.



Permeable Unit Pavers Eco-Priora by Unilock

| <u>Species</u> | DBH | Healt |
|----------------|------------|-------|
| Ailanthus | 26" | good |
| Sycamore maple | 6.5" | good |
| Sycamore maple | 14" | fair |
| Sycamore maple | 14" | fair |
| Sycamore maple | 8" | fair |
| Sycamore maple | 8'' + 14'' | fair |
| Sycamore maple | 6.5" | fair |
| Sycamore maple | 13" | fair |
| Sycamore maple | 18" | fair |
| Sycamore maple | 22" | fair |
| Sycamore maple | 20" | poor |
| zelkova | 5" | good |

PLANTING NOTES

- 1. All plant material shall be approved by the Landscape Architect prior to arrival on the site.
- 2. All plant material shall conform to the guidelines established by "The American Standard for Nursery Stock", published by the American Association of Nurserymen, Inc.
- 3. No substitution of plant species will be allowed without the approval of the Landscape Architect.
- 4. The Contractor shall locate and verify all utility line locations prior to staking and report any conflicts to the Landscape Architect.
- 5. All plants shall be staked out in their approximate location by the Contractor. The Contractor shall adjust the locations of these stakes as required by the Landscape Architect to account for subsurface utilities, other field conditions and to achieve design intent. Final locations must be approved by the Landscape Architect prior to planting.
- 6. No planting shall be installed before acceptance of rough grading of topsoil.
- 7. The rootballs of trees shall be planted 3" above adjacent finished grade. Excavate holes no deeper than the rootball of trees. Holes shall be at least 3' greater in diameter than root ball. Backfill planting hole with 'planting mix'. All plants which settle out of plumb or below finished grade shall be immediately replanted.
- 8. The rootballs of shrubs shall be planted 2" above adjacent finished grade. Excavate holes no deeper than the rootball of shrubs.
- 9. All shrubs, groundcovers and perennials shall be planted in continuous planting beds. All beds shall be excavated 12" and the topsoil and subsoil set aside for reuse. Remove all stone and debris from excavated soil. Backfill beds with 12" of 'planting mix' before planting shrubs, perennials and groundcovers.
- 10. 'Planting Mix' shall consist of 2 parts of topsoil saved from site excavations and 1 part compost. Thoroughly mix to create uniform blended mixture. If insufficient topsoil is available on the site, mix existing soil in a ratio of 1 part soil to 1 part compost. Remove all stones and debris larger than 2" from planting mix.
- 11. All beds as shown on the drawings shall be edged with a 4" trench neatly cut and backfilled with bark mulch. All beds shall be covered with no less than 2"depth settled bark mulch and no greater than 3" depth bark mulch.
- 12. All plants are to be thoroughly watered after installation, at least twice within the first 24 hours.














ROOF DECKS - FIFTH FLOOR

3 HAWKINS STREET


SOMERVILLE, MA

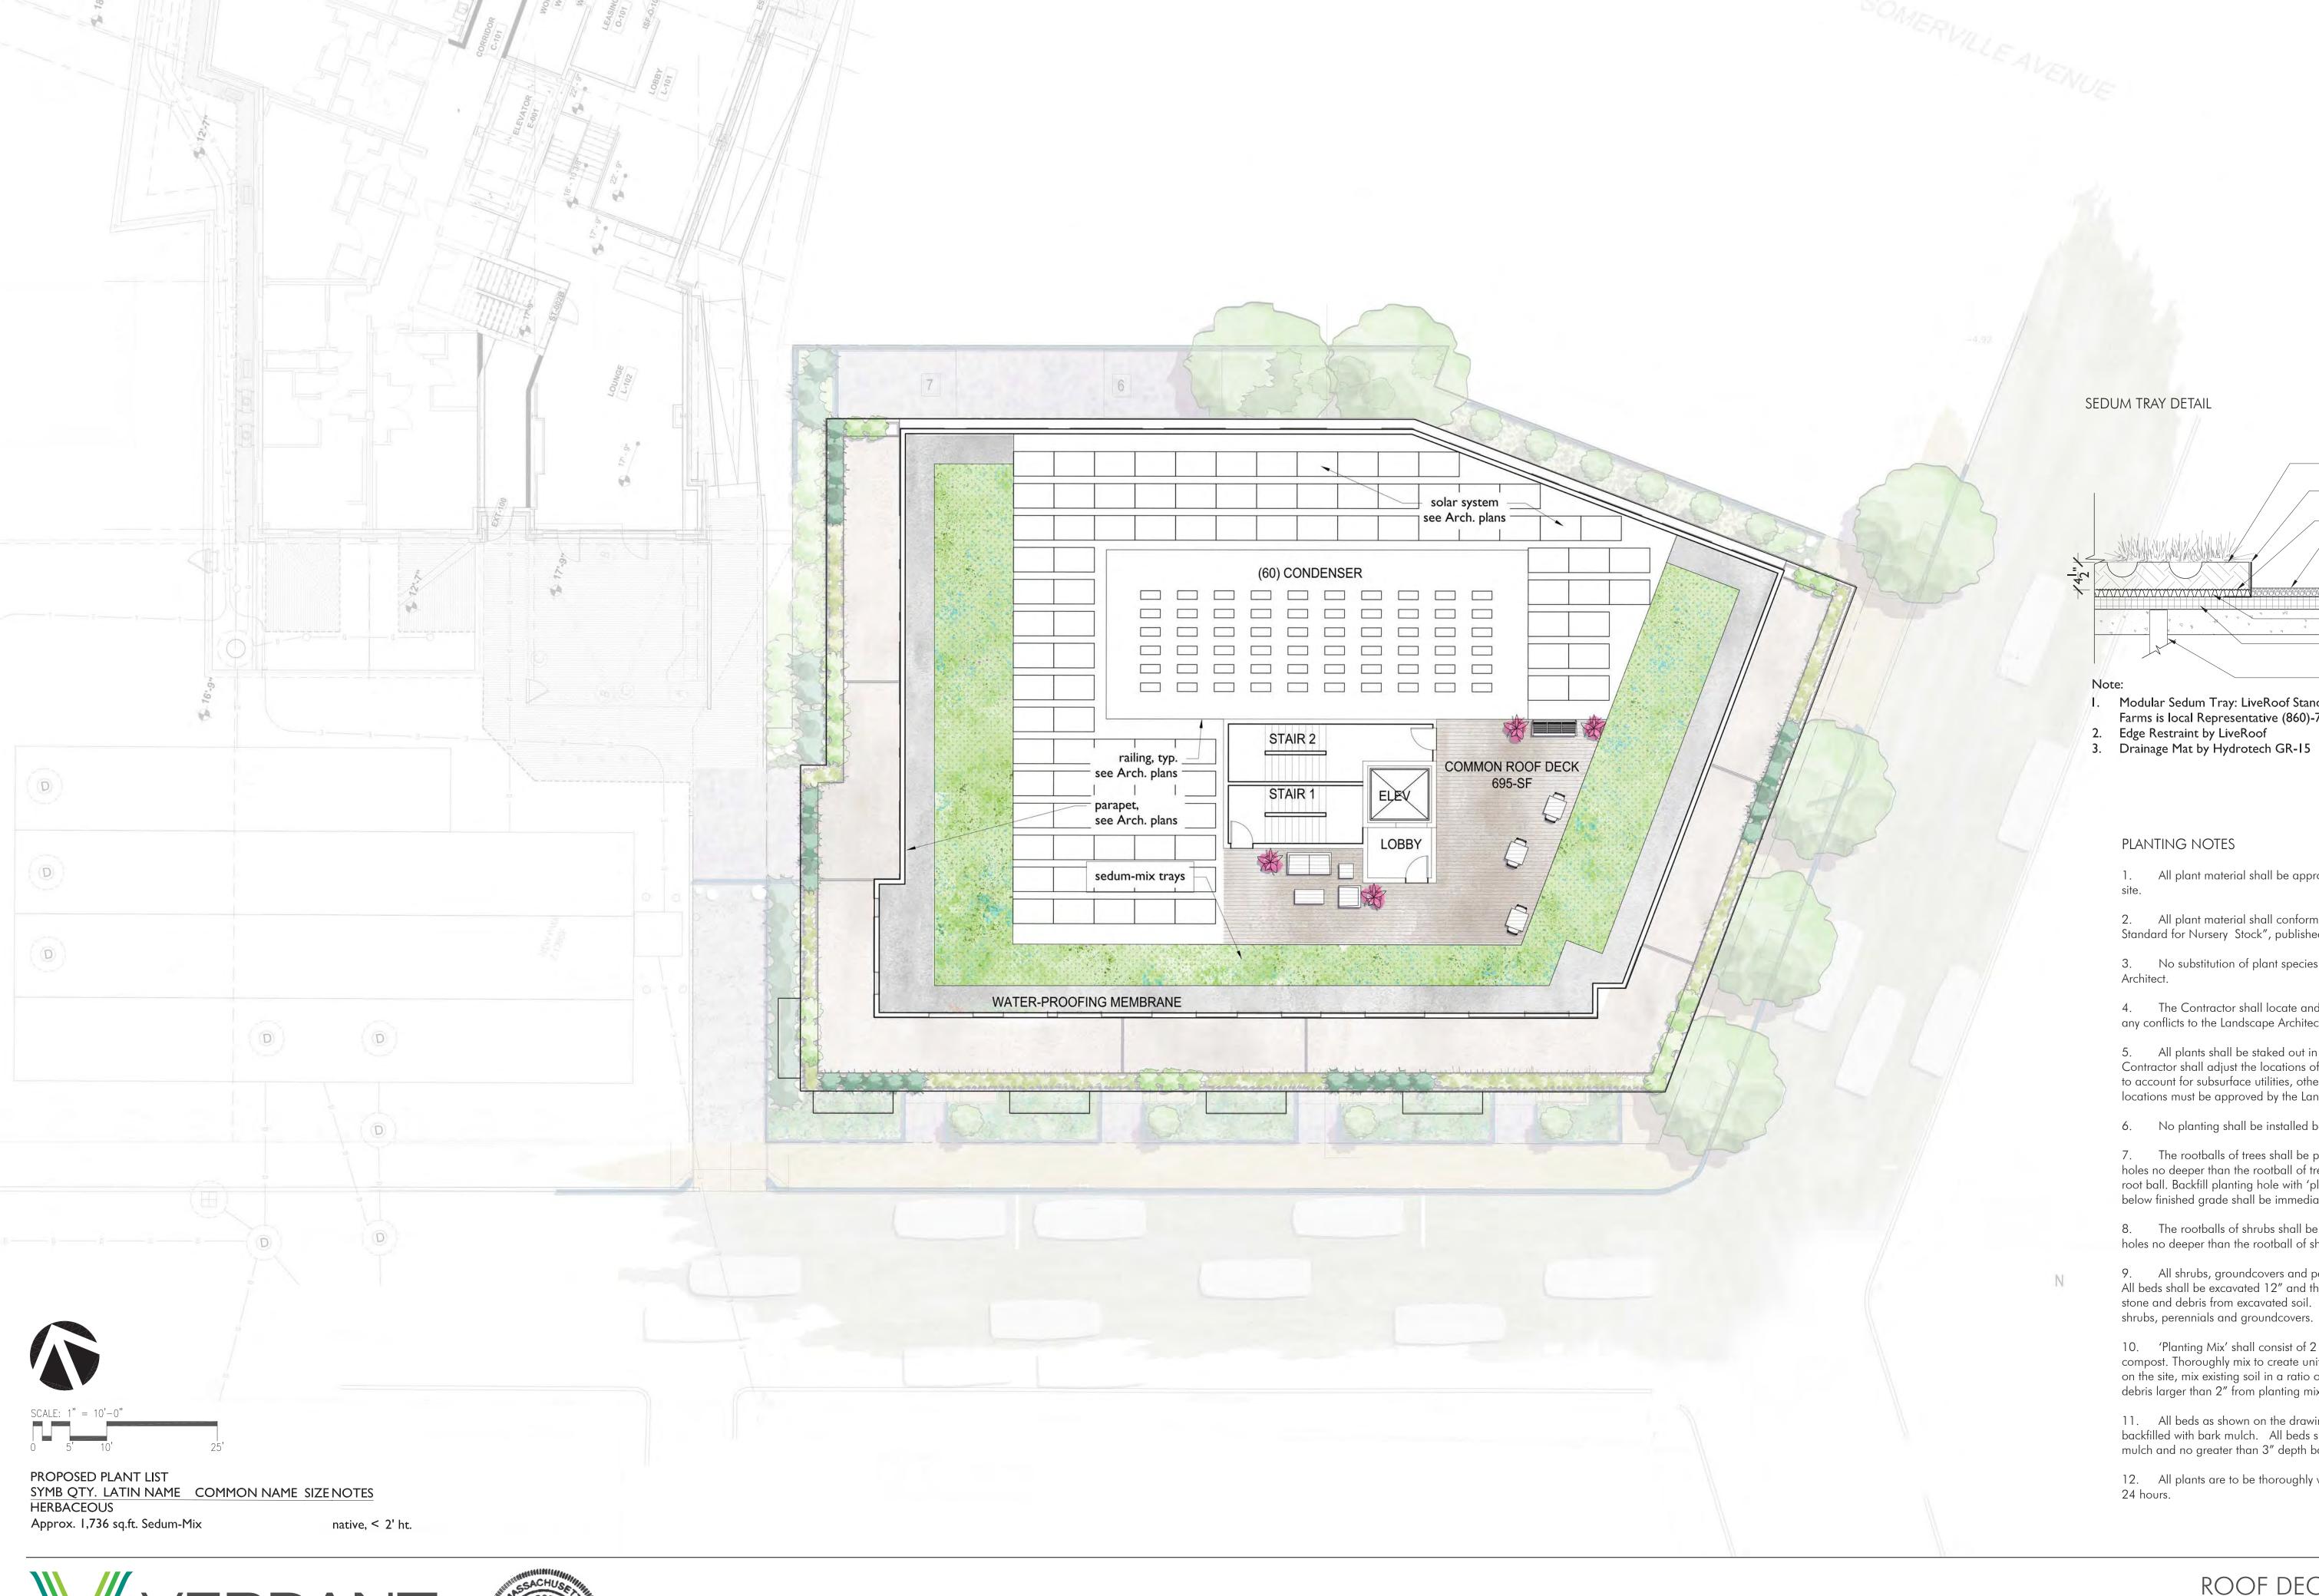



Modular Sedum Tray, see note 4.25" Edge Restraint, see note Filter Fabric, see note Ballast, by Architects GRI5 Garden Drain, see note

Drain, see MEP plans I. Modular Sedum Tray: LiveRoof Standard System, $4\frac{1}{2}$ " depth, by LiveRoof, Prides Corner Farms is local Representative (860)-710-8512

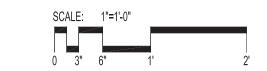

Waterproofing, Protection Board, Insulation, see Architectural drawings.

PLANTING NOTES

- 1. All plant material shall be approved by the Landscape Architect prior to arrival on the
- 2. All plant material shall conform to the guidelines established by "The American Standard for Nursery Stock", published by the American Association of Nurserymen, Inc.
- 3. No substitution of plant species will be allowed without the approval of the Landscape
- 4. The Contractor shall locate and verify all utility line locations prior to staking and report any conflicts to the Landscape Architect.
- 5. All plants shall be staked out in their approximate location by the Contractor. The Contractor shall adjust the locations of these stakes as required by the Landscape Architect to account for subsurface utilities, other field conditions and to achieve design intent. Final locations must be approved by the Landscape Architect prior to planting.
- 6. No planting shall be installed before acceptance of rough grading of topsoil.
- 7. The rootballs of trees shall be planted 3" above adjacent finished grade. Excavate holes no deeper than the rootball of trees. Holes shall be at least 3' greater in diameter than root ball. Backfill planting hole with 'planting mix'. All plants which settle out of plumb or below finished grade shall be immediately replanted.
- 8. The rootballs of shrubs shall be planted 2" above adjacent finished grade. Excavate holes no deeper than the rootball of shrubs.
- 9. All shrubs, groundcovers and perennials shall be planted in continuous planting beds. All beds shall be excavated 12" and the topsoil and subsoil set aside for reuse. Remove all stone and debris from excavated soil. Backfill beds with 12" of 'planting mix' before planting shrubs, perennials and groundcovers.
- 10. 'Planting Mix' shall consist of 2 parts of topsoil saved from site excavations and 1 part compost. Thoroughly mix to create uniform blended mixture. If insufficient topsoil is available on the site, mix existing soil in a ratio of 1 part soil to 1 part compost. Remove all stones and debris larger than 2" from planting mix.
- 11. All beds as shown on the drawings shall be edged with a 4" trench neatly cut and backfilled with bark mulch. All beds shall be covered with no less than 2"depth settled bark mulch and no greater than 3" depth bark mulch.
- 12. All plants are to be thoroughly watered after installation, at least twice within the first



















Concrete Pedestal Pavers

Wood Pedestal Pavers by Bison

Planter & Pedestal Paver System

Fiberglass Planters by ORE



Cornus sericea 'Artic Fire' Dwarf Redtwig Dogwood



Juniperus squamata 'Blue Star' Flaky Juniper




Miscanthus sinensis 'Little Kitten' Dwarf Maiden Grass




Sedum Mix Mat by Sempergreen




TYPICAL PLANT (TREE OR SHRUB) DETAIL

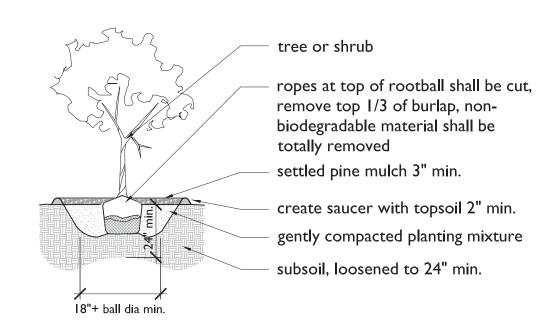


PERMEABLE UNIT PAVER DETAIL

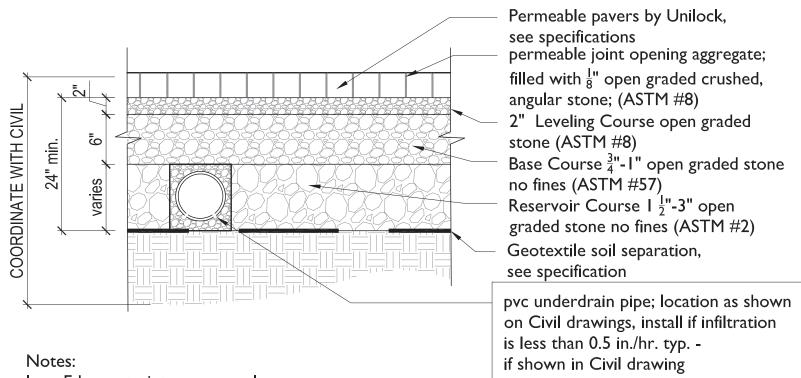


- Edge restraints vary see plan.
- 2. All aggregate material shall be crushed, angular stone and free of fines.
- 3. Compact subsoil with a California bearing ratio (cbr) of less than 5% as directed by a professional engineer.
- 4. Surface slope shall be a minimum of 1% and a maximum of 5%.
- 5. Install pvc underdrain pipe where infiltration rate of subsoil is less than 0.5 in./hr. size as directed by a professional engineer.
- 6. Never build permeable pavements on organic clay soils of high plasticity and/or peat, mulch, soils with high organic content.
- 7. Maintain a minimum distance of 2' between bottom of permeable base and water
- 8. The minimum aggregate thicknesses are after compaction.

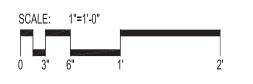

Typical perennial detail

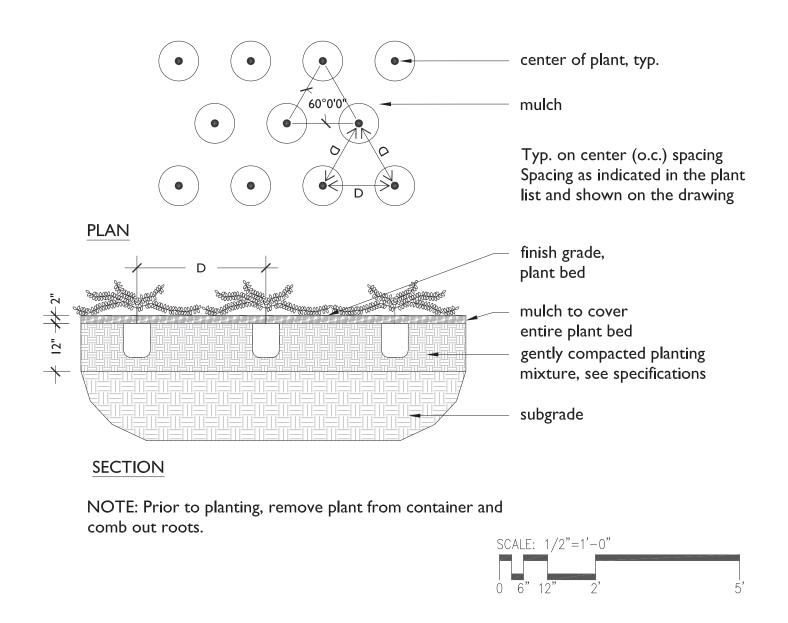

GREEN SCREEN DETAIL

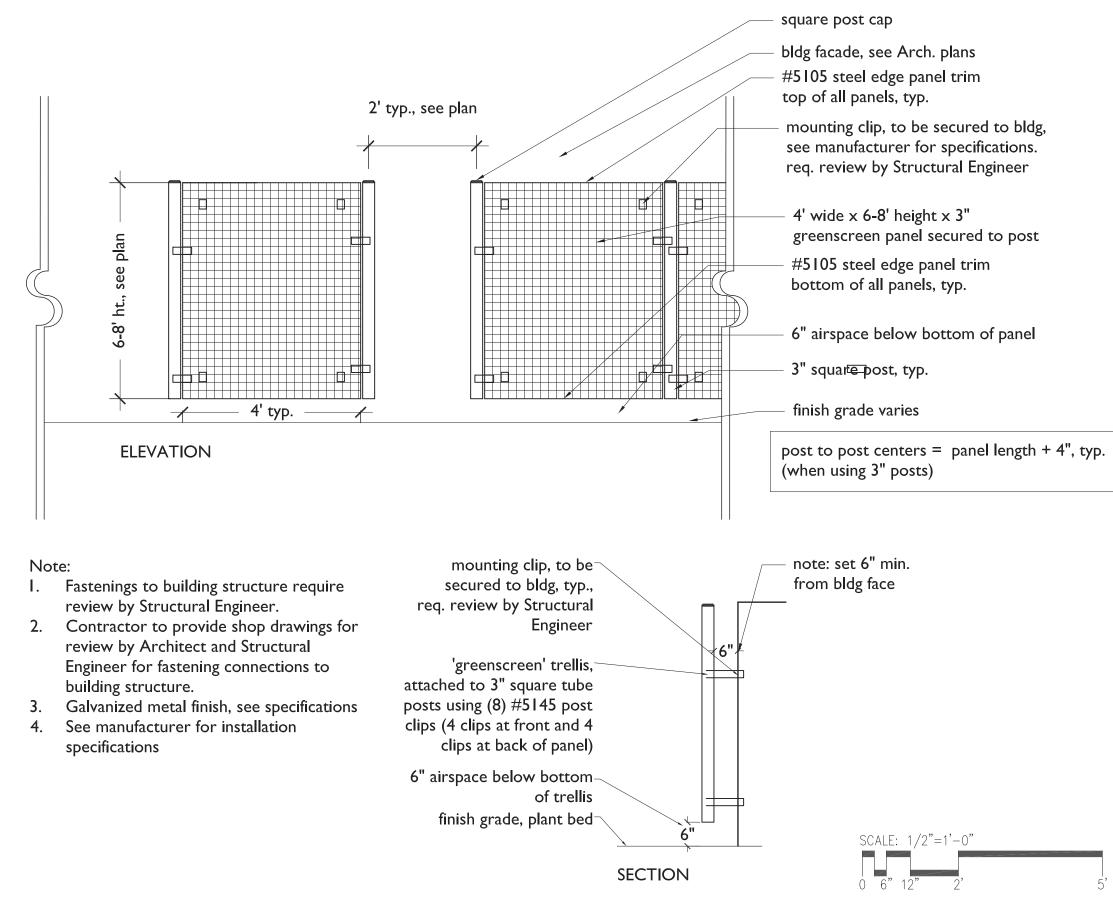





REVISED APRIL 8, 2021

10. DEVELOPMENT STANDARDS

Green Score

Table 10.4.1 Green Score Calculation

| | Credit | Multiplier | |
|---|-----------|--|--|
| Soils | | | |
| Landscaped area with a soil depth < 24 inches | actual sf | 0.3 | |
| Landscaped area with a soil depth => 24 inches | actual sf | 0.6 | |
| Pervious Paving with 6 to 24 inches of subsurface soil or gravel | actual sf | 0.2 | |
| Pervious Paving with more than 24 inches of subsurface soil or gravel | actual sf | 0.5 | |
| Groundcovers | | | |
| Turfgrass, mulch, and inorganic surfacing materials | actual sf | 0.1 | |
| Plants | | | |
| Vegetation less than two (2) feet tall at maturity | actual sf | 0.2 | |
| Vegetation at least two (2) feet tall at maturity | 12 sf. | 0.3 | |
| Trees | | | |
| SMALL TREE | 50 sf. | 0.6 | |
| Large Tree | 450 sf. | 0.6 | |
| Preserved Tree | 65 sf. | 0.8 | |
| Engineered Landscape | | | |
| Vegetated Wall | actual sf | 0.1 | |
| Rain gardens, bioswales, and stormwater PLANTERS. | actual sf | 1.0 | |
| Green Roof with up to 6" of growth medium | actual sf | 0.1 | |
| Green Roof with 6"-10" of growth medium | actual sf | 0.4 | |
| Green Roof of 10"-24" growth medium | actual sf | 0.6 | |
| Green Roof of over 24" growth medium | | per individual landscape elements | |

Green Score is a performance-based environmental landscape standard measured as a ratio of the weighted value of all landscape elements to the total land area of a lot.

3 Hawkins Street 13,950.6 SF Total

| Key | | Multiplier | Bonus | Credit | |
|-----|---|------------|-------|---------|---------|
| A | Soils Landscaped Area with a soil depth => 24 inches | .6 | | 1,076.4 | 645.8 |
| В | Soils Pervious Paving with more than 24 inches of subsurface soil or gravel | .5 | > | 426.9 | 213.5 |
| С | Plants Vegetation less than two feet tall at maturity | .2 | PV .1 | 18.1 | 5.4 |
| D | Plants Vegetation at least two feet tall at maturity | .3 | NS.1 | (197)12 | 945.6 |
| Е | Trees Small Tree | .6 | NS .1 | (10)50 | 350 |
| F | Trees Large Tree | .6 | NS .1 | (2)450 | 630 |
| G | Engineered Landscape Vegetated Wall | .1 | NS .1 | 200 | 40 |
| Н | Engineered Landscape Green Roof with up to 6" of growth medium | .1 | NS .1 | 1735.7 | 347.1 |
| I | Engineered Landscape Green Roof of 10"-24" growth medium | .6 | > | 577.3 | 346.4 |
| | Total | | | | 3,523.8 |
| | Green Score Bonus Publicly Visible Landscape = PV = .1 Native Species = NS = .1 | | | | |



| | Credit | Multiplier |
|---|--------|------------|
| Bonus Credits | | |
| Publicly visible landscape | | 0.1 |
| Native species | - | 0.1 |
| High value species | - | 0.1 |
| 50% of irrigation is harvested rainwater | 121 | 0.1 |
| Food cultivation | | 0.1 |
| De-paved LOT AREA | 11 | 0.1 |


3,523.8 / 13,950.6 = .25 Green Score minimum .20 required



Ground Level



5th Floor

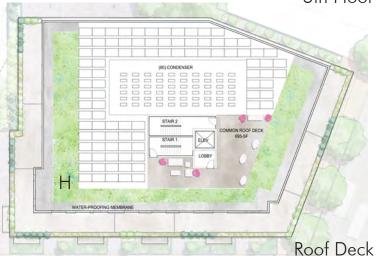



3 HAWKINS STREET SOMERVILLE, MA

REVISED APRIL 8, 2021

